




DRAWING LIST - WORKING DRAWINGS

Layout ID	Layout Name	Drawing Scales
A00	COVER	
A00-01	GENERAL NOTES AND LEGENDS	1:1
A02-01	BASEMENT PLAN	1:100
A02-02	GROUND FLOOR PLAN	1:100
A02-03	FIRST FLOOR PLAN	1:100
A02-04	SECOND FLOOR PLAN	1:100
A02-05	ROOF PLAN	1:100
A04-01	RCP - GROUND FLOOR	1:100
A05-01	ELEVATIONS - NORTH, EAST	1:100
A05-02	ELEVATIONS - SOUTH, WEST	1:100
A06-01	SECTION A-A: LONGITUDINAL	1:100
A06-02	SECTION B-B: LATERAL	1:100
A06-03	SECTION C-C: BASEMENT DETAILS	1:50
A07-01	WALL TYPES SCHEDULE: SHEET 1	1:10
A07-02	WALL TYPES SCHEDULE: SHEET 2	1:10
A07-03	DETAIL WALL SECTIONS	1:20
A08-01	VERTICAL CIRCULATION - LIFT, STAIRS	1:50
A09-01	DETAILS SHEET 1 - GREEN ROOF/ TERRACE	1:10
A09-02	DETAILS SHEET 2 - TYPICAL BALCONY	1:10
A09-03	DETAILS SHEET 3 - GROUND/ ENTRY	1:10
A09-04	DETAILS SHEET 4 - BASEMENT SLAB	1:10
A15-01	KEY INTERNAL AREAS - APARTMENT FITOUT	1:50
A15-02	KEY INTERNAL AREAS - TYPICAL KITCHEN	1:20
A16-01	DOOR SCHEDULE	1:50
A16-02	WINDOW SCHEDULE	1:50

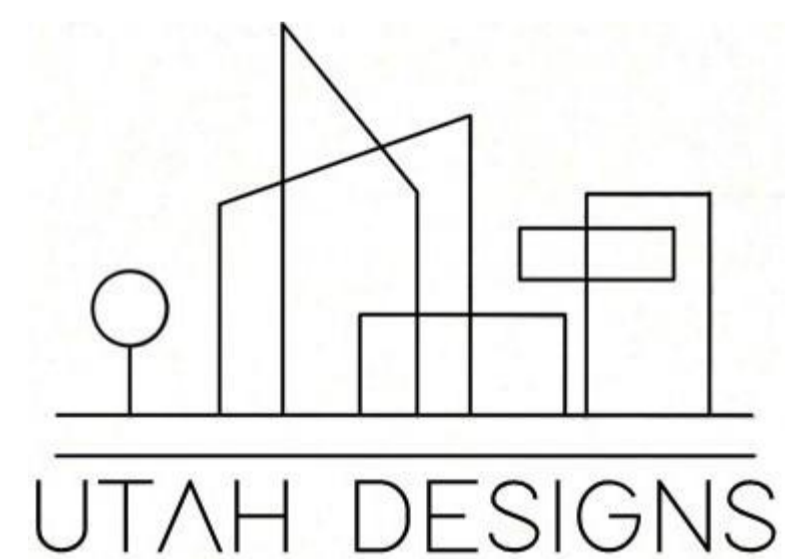

THE NEOGRANDE APARTMENTS

AT4.2 APARTMENT BUILDING

JAXON BELL

GENERAL NOTES

THE PRELIMINARY DRAWINGS INDICATE ARCHITECTURAL INTENT ONLY AND MUST BE READ IN ACCORDANCE WITH ALL RELEVANT CONSULTANTS DRAWINGS AND APPLICABLE STANDARDS.

IT IS THE CONTRACTORS RESPONSIBILITY TO ENSURE THE BUILDABILITY OF THESE ITEMS, SUCH AS GLAZING, BALUSTRADING, CURTAIN WALLS

REFER TO STRUCTURAL ENGINEERS DRAWINGS FOR STRUCTURAL SIZES AND NOMINATIONS.

INSULATION REQUIRED TO ALL METAL ROOFING TO COMPLY WITH MECHANICAL AND ACOUSTIC REQUIREMENTS.

GENERALLY ALLOW FOR CLADDING TO HYDRAULIC SERVICES RISES AND PIPEWORK TO COMPLY WITH ACOUSTIC REQUIREMENTS.

GENERALLY ALLOW FOR CLADDING ALL EXPOSED DOWNPIPES IN POWDERCOAT ALUMINIUM BOXED SHEETING OR AS OTHERWISE NOMINATED

PROVIDE FOR TERMITE PROTECTION TO A.S. REQUIREMENTS TERMIMESH OR SIMILAR APPROVED, REFER TO SPECIFICATION

ALL WET AREAS TO HAVE WR/MR PLASTERBOARD TO ALL WALLS AND CEILINGS AND MR FIRESTOP PLASTERBOARD WHERE FIRESTOP PLASTERBOARD IS REQUIRED FOR ACOUSTIC & FIRE SEPARATION. WET AREAS INCLUDE BATHROOMS, LAUNDRIES, KITCHENS, WC, ENSUITES, SHOWERS

ALL WET AREA FLOORS TO HAVE SCREED APPLIED TO CREATE FALLS TO FLOOR WASTES UNLESS NOTED OTHERWISE.

ALL WET AREA DETAILS AND WATERPROOFING TO COMPLY WITH AS3740.

ALL CONSTRUCTION & PROPRIETARY SYSTEMS, FITTINGS & FIXTURES TO BE INSTALLED IN ACCORDANCE WITH MANUFACTURER'S PROCEDURES, INSTRUCTIONS AND RECOMMENDATIONS.

PROVIDE NOGGINGS IN WALLS TO TAKE ALL FITTING FIXINGS INCLUDING TOWELS RAILS. HAND RAILS, TOILET ROLL HOLDERS, SOAP HOLDERS, SHELVES, LAUNDRY DRYER SUPPORTS ETC.

CONTRACTOR TO CHECK ALL CRITICAL DIMENSIONS PRIOR TO COMMENCING WORK ON SITE.

ALL DIMENSIONS TO PLANS, ELEVATIONS & SECTIONS ARE TO FINISHED FLOOR LEVELS &/OR FINISHED SURFACES / JUNCTIONS UNLESS OTHERWISE SPECIFIED

LEGENDS

A

AG ARCHITECTURAL GRILLE
AC AIR CONDITIONING VENT

B

B BASIN

C

COL COLUMN

D

DO DRAINAGE OUTLET
DP DOWNPIPE
DW DISHWASHER

F

FH FIRE HYDRANT
FHC FULL HEIGHT CABINET
FHB FIRE HYDRANT BOOSTER
FIP FIRE INDICATOR PANEL
FW FLOOR WASTE

H

HB HOSE BIB TAP

M

MSB MAIN SWITCHBOARD

O

OF OVERFLOW
OV/CT OVEN / COOKTOP

R

RG RANGE OVEN
RH RANGE HOOD
RWH RAINWATER HEAD
RWP RAINWATER PUMP
REF REFRIGERATOR

S

SHR SHOWER









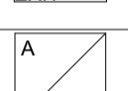
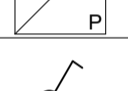
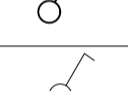
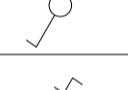
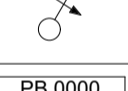
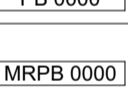
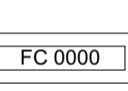
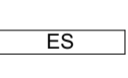
T

TD THRESHOLD DRAIN
TP TELSTRA PIT

W

WC TOILET SUITE
WM WATER METER CUPBOARD

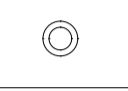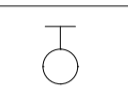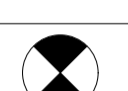LEGEND - RCP SYMBOLS

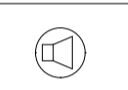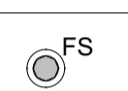DP	DOWNPIPE
FH	FIRE HYDRANT
EF	EXHAUST FAN
	RECESSED LED DOWNLIGHT
D2	IP44 RECESSED LED DOWNLIGHT - BATHROOMS & EXTERNAL
	EXTERIOR WALL MOUNTED LIGHT
F1	IP66 32W (3200LM) LED DIFFUSED BATTEN
	CEILING RECESSED EMERGENCY LUMINARE
	SMOKE DETECTOR TO AS 1670
	RESIDENTIAL SMOKE DETECTOR TO AS 1670
	CEILING FLUSH MOUNTED LOUDSPEAKER
	FIRE SPRINKLER
	EXIT SIGN
	CEILING ACCESS PANEL
	ONE WAY SWITCH
	TWO WAY SWITCH
	DIMMER LIGHT SWITCH
	FLUSH PLASTERBOARD AT HEIGHT AS SHOWN
	MOISTURE RESISTANT FLUSH PLASTERBOARD AT HEIGHT AS SHOWN
	FIBRE CEMENT SHEET AT HEIGHT AS SHOWN
	EXPOSED CEILING / STRUCTURE

FINISHES

EXTERNAL FINISHES

EF-01	CSR 20mm STONE PANELS - SANDSTONE FINISH
EF-02	CEMENT SHEET & MOULDINGS - WHITE RENDER FINISH
EF-03	FLUTED CONCRETE PANEL - LIGHT BROWN FINISH
EF-04	CONCRETE FACADE TILES - GRAY FINISH (ROUGH)
EF-05	BALLUSTRADE GLAZING - CLEAR
EF-06	TIMBER - DARK OAK
EF-07	ALUMINIUM LOUVRE GRILLE - POWDER COAT TO MATCH EF-01

FINISHES - KITCHEN

TR-01	PINE LINING WHITE PAINT FINISH
TR-02	BRUSHED BRASS TRIM
CD-01	CUPBOARD DOOR - OFF WHITE
CD-02	CUPBOARD DOOR - LIGHT BROWN
CD-03	CUPBOARD DOOR - FLUTED GLASS
ST-01	STONE BENCHTOP - MARBLE

Rev	ChID	Description	Date
A	F	FINAL SUBMISSION	12/06/26

NOTES:

THE BUILDER SHALL CHECK AND VERIFY ALL DIMENSIONS AND NOTIFY ALL ERRORS AND OMISSIONS TO THE DESIGNER.
DO NOT SCALE DRAWINGS.
USE FIGURED DIMENSIONS ONLY. DRAWINGS ARE NOT TO BE USED FOR CONSTRUCTION UNTIL ISSUED BY THE DESIGNER FOR CONSTRUCTION.

STUDENT DECLARES THAT THIS ASSESSMENT TASK IS HER/HIS OWN WORK UNLESS OTHERWISE ACKNOWLEDGED AND IS IN ACCORDANCE WITH THE INSTITUTE'S PLAGIARISM POLICY. STUDENT ACKNOWLEDGES THAT THE ASSESSOR OF THIS ASSESSMENT TASK MAY:
1. REPRODUCE THIS ASSESSMENT TASK AND PROVIDE A COPY TO ANOTHER MEMBER OF THE INSTITUTE OR DISPLAY THIS ASSESSMENT WITHIN THE INSTITUTE FOR EDUCATIONAL PURPOSES. 2. SUBMIT THE ASSESSMENT TASK TO PLAGIARISM CHECKING.

JAXON BELL

100660344

22477VIC

Advanced Diploma of Building Design (Architectural)

holmesglen

AT4.2 APARTMENT BUILDING

9-11 BEVIS STREET BENTLEIGH EAST VIC 3165 AUSTRALIA

DRAWING NAME:
GENERAL NOTES AND LEGENDS

FILE: WD_AT4.2_APARTMENT BUILDING.pln


DATE: 14/06/2026

CHECKED: TEACHER

DWG NO: REVISION:


A00-01 A

SCALE: 1:1 at A1

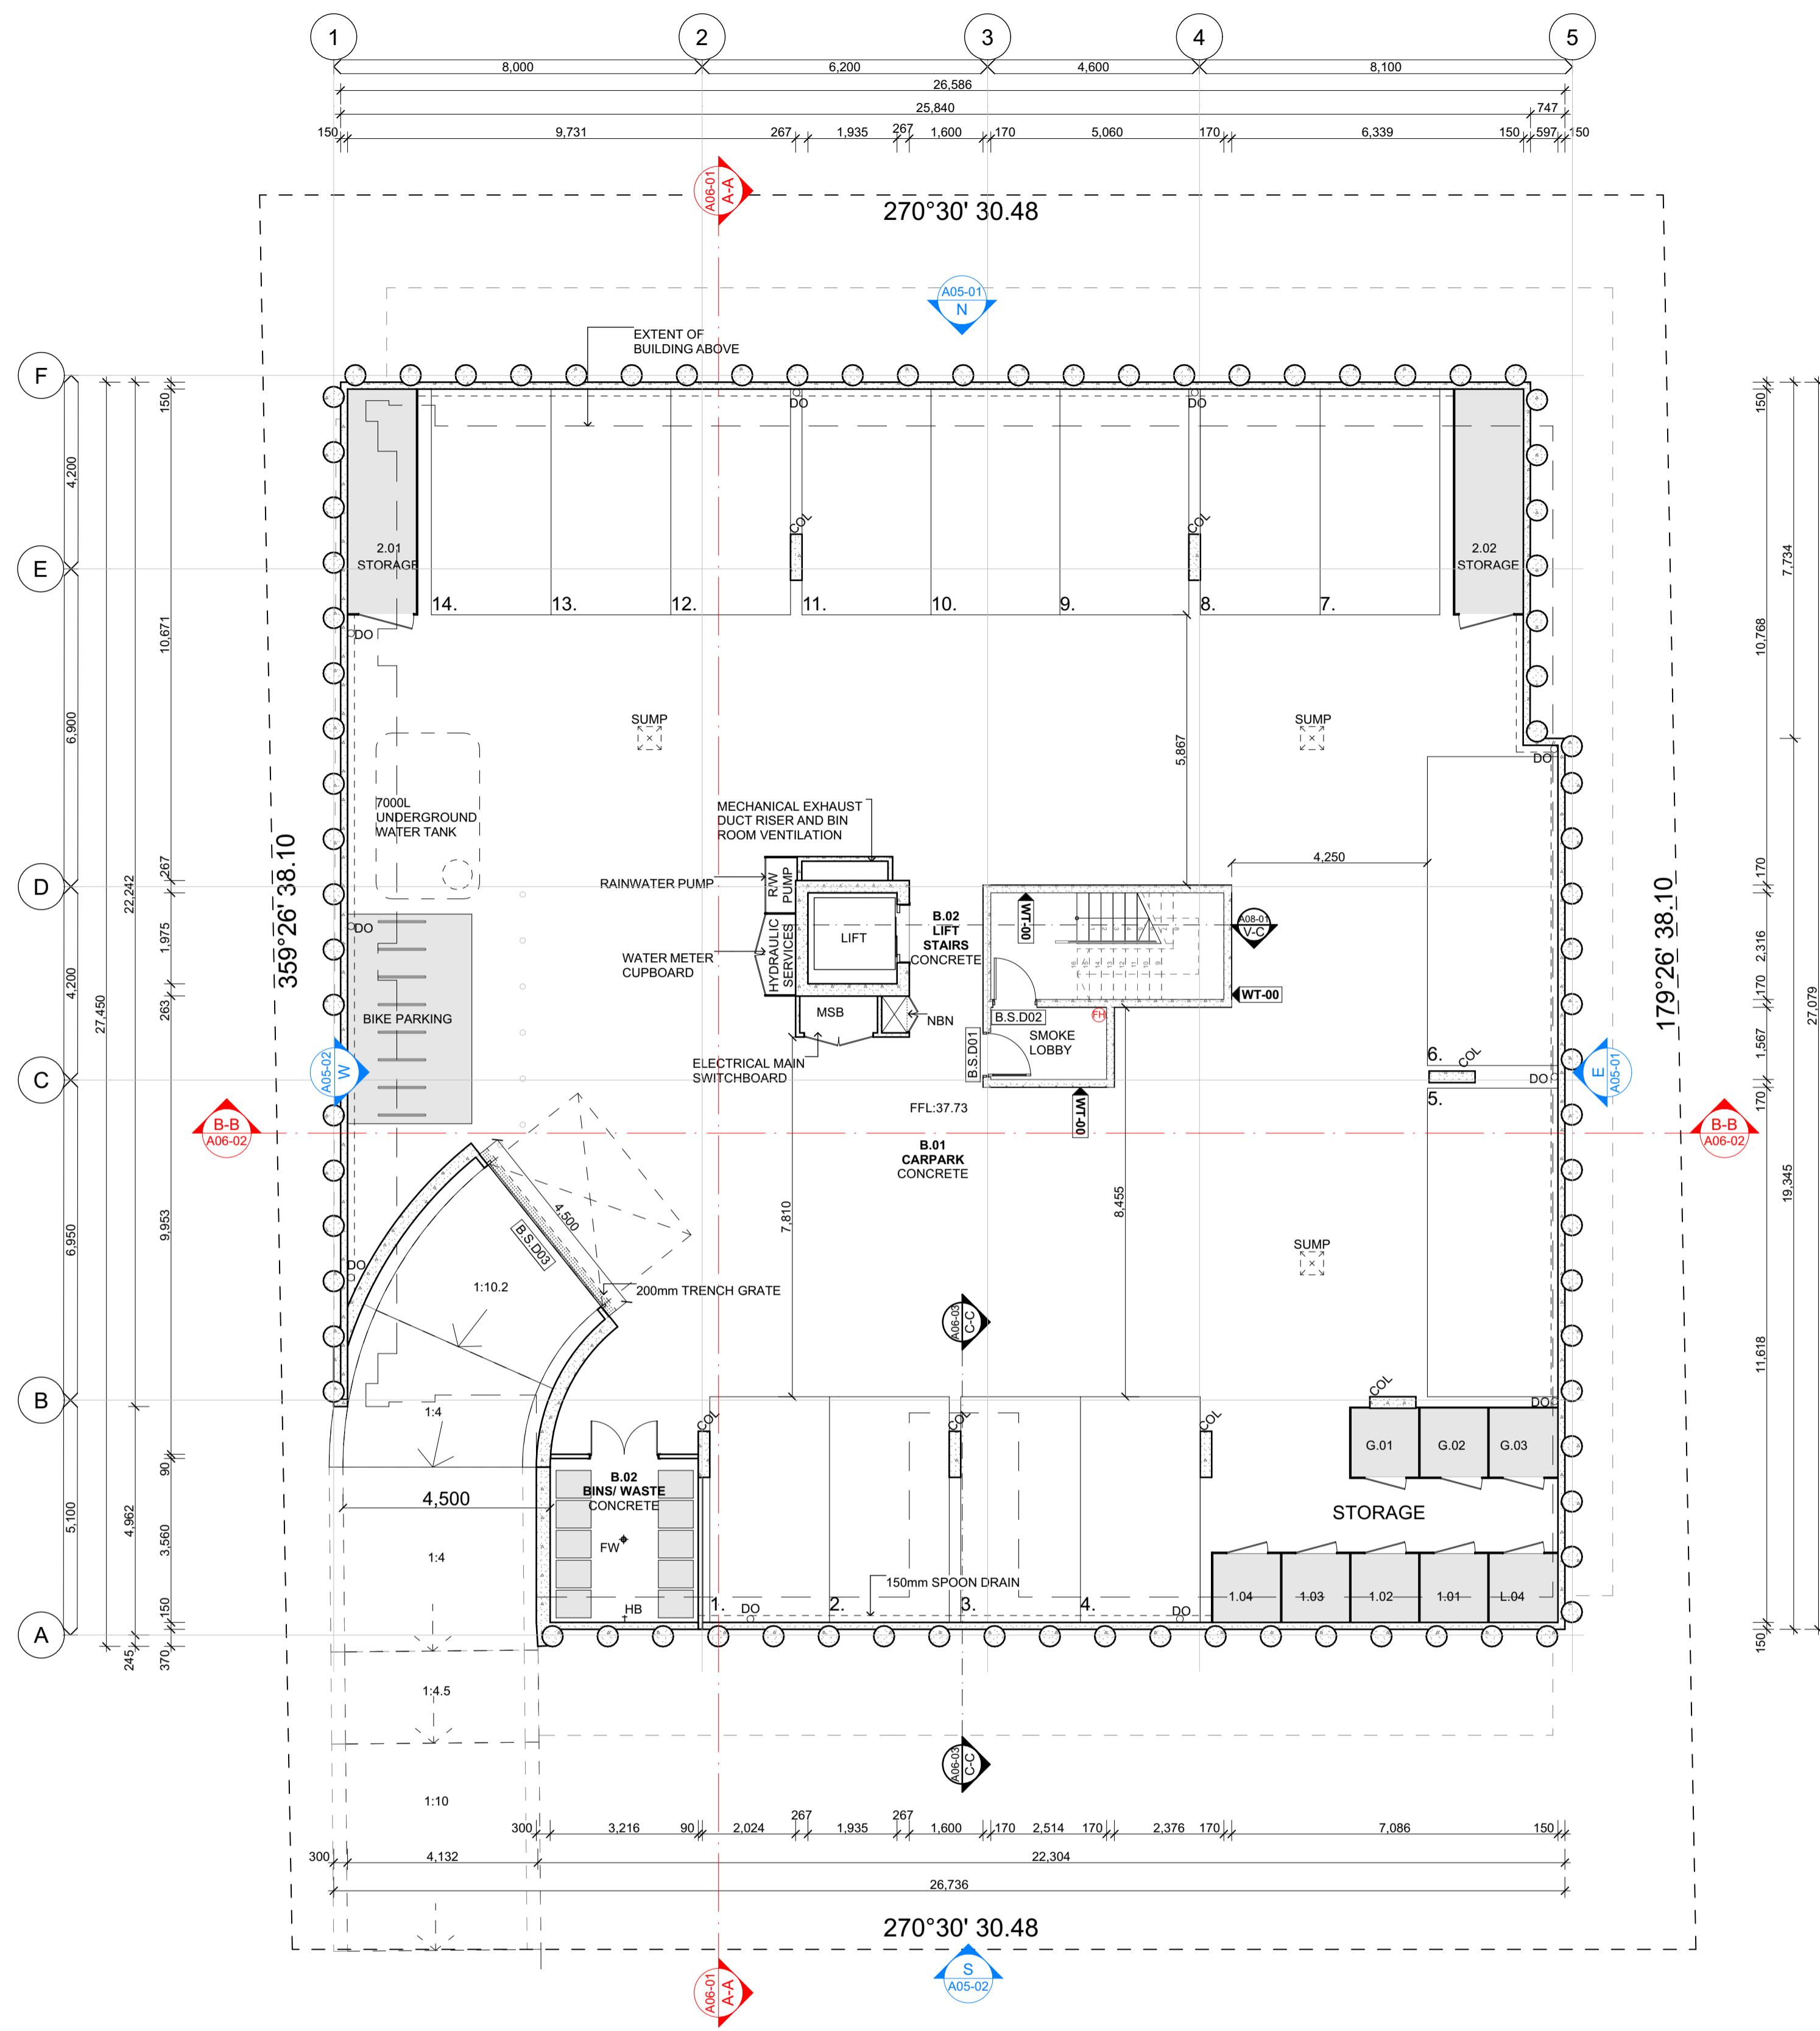


LEGEND	
DO	DRAINAGE OUTLET
HB	HOSE BIB TAP
FH	FIRE HYDRANT
FW	FLOOR WASTE
MSB	MAIN SWITCHBOARD
COL	COLUMN

A02-01 BASEMENT PLAN
1:100

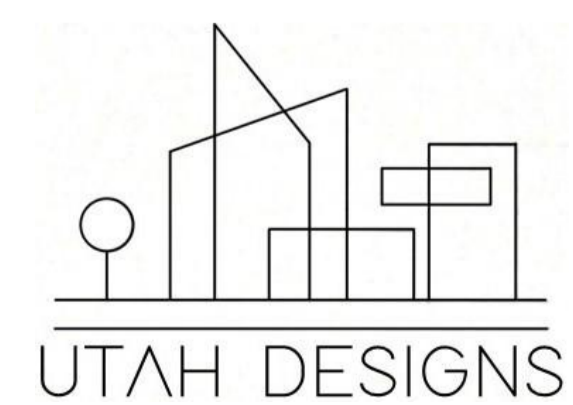

Rev	ChID	Description	Date
P		PRELIMINARY SUBMISSION	15/05/26
P		TR PRELIMINARY SUBMISSION	4/06/26
A	F	FINAL SUBMISSION	12/06/26

NOTES:
 THE BUILDER SHALL CHECK AND VERIFY ALL DIMENSIONS AND NOTIFY ALL ERRORS AND OMISSIONS TO THE DESIGNER.
 DO NOT SCALE DRAWINGS.
 USE FIGURED DIMENSIONS ONLY. DRAWINGS ARE NOT TO BE USED FOR CONSTRUCTION UNTIL ISSUED BY THE DESIGNER FOR CONSTRUCTION.
 STUDENT DECLARES THAT THIS ASSESSMENT TASK IS HER/HIS OWN WORK UNLESS OTHERWISE ACKNOWLEDGED AND IS IN ACCORDANCE WITH THE INSTITUTE'S PLAGIARISM POLICY. STUDENT ACKNOWLEDGES THAT THE ASSESSOR OF THIS ASSESSMENT TASK MAY:
 1. REPRODUCE THIS ASSESSMENT TASK AND PROVIDE A COPY TO ANOTHER MEMBER OF THE INSTITUTE OR DISPLAY THIS ASSESSMENT WITHIN THE INSTITUTE FOR EDUCATIONAL PURPOSES. 2. SUBMIT THE ASSESSMENT TASK TO PLAGIARISM CHECKING.

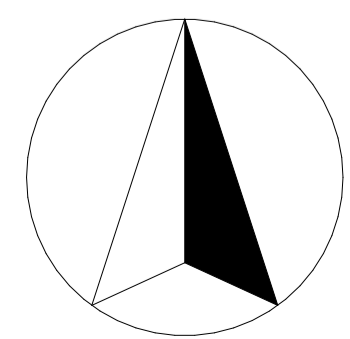

JAXON BELL
 100660344
 22477VIC
 Advanced Diploma of Building Design (Architectural)

holmesglen

AT4.2 APARTMENT BUILDING
 9-11 BEVIS STREET BENTLEIGH EAST
 VIC 3165 AUSTRALIA


DRAWING NAME:
 BASEMENT PLAN

FILE: WD_AT4.2_APARTMENT BUILDING.pln

DATE: 14/06/2026 **CHECKED:** TEACHER


DWG NO: A02-01 **REVISION:** A

SCALE: 1:100 **at** A1

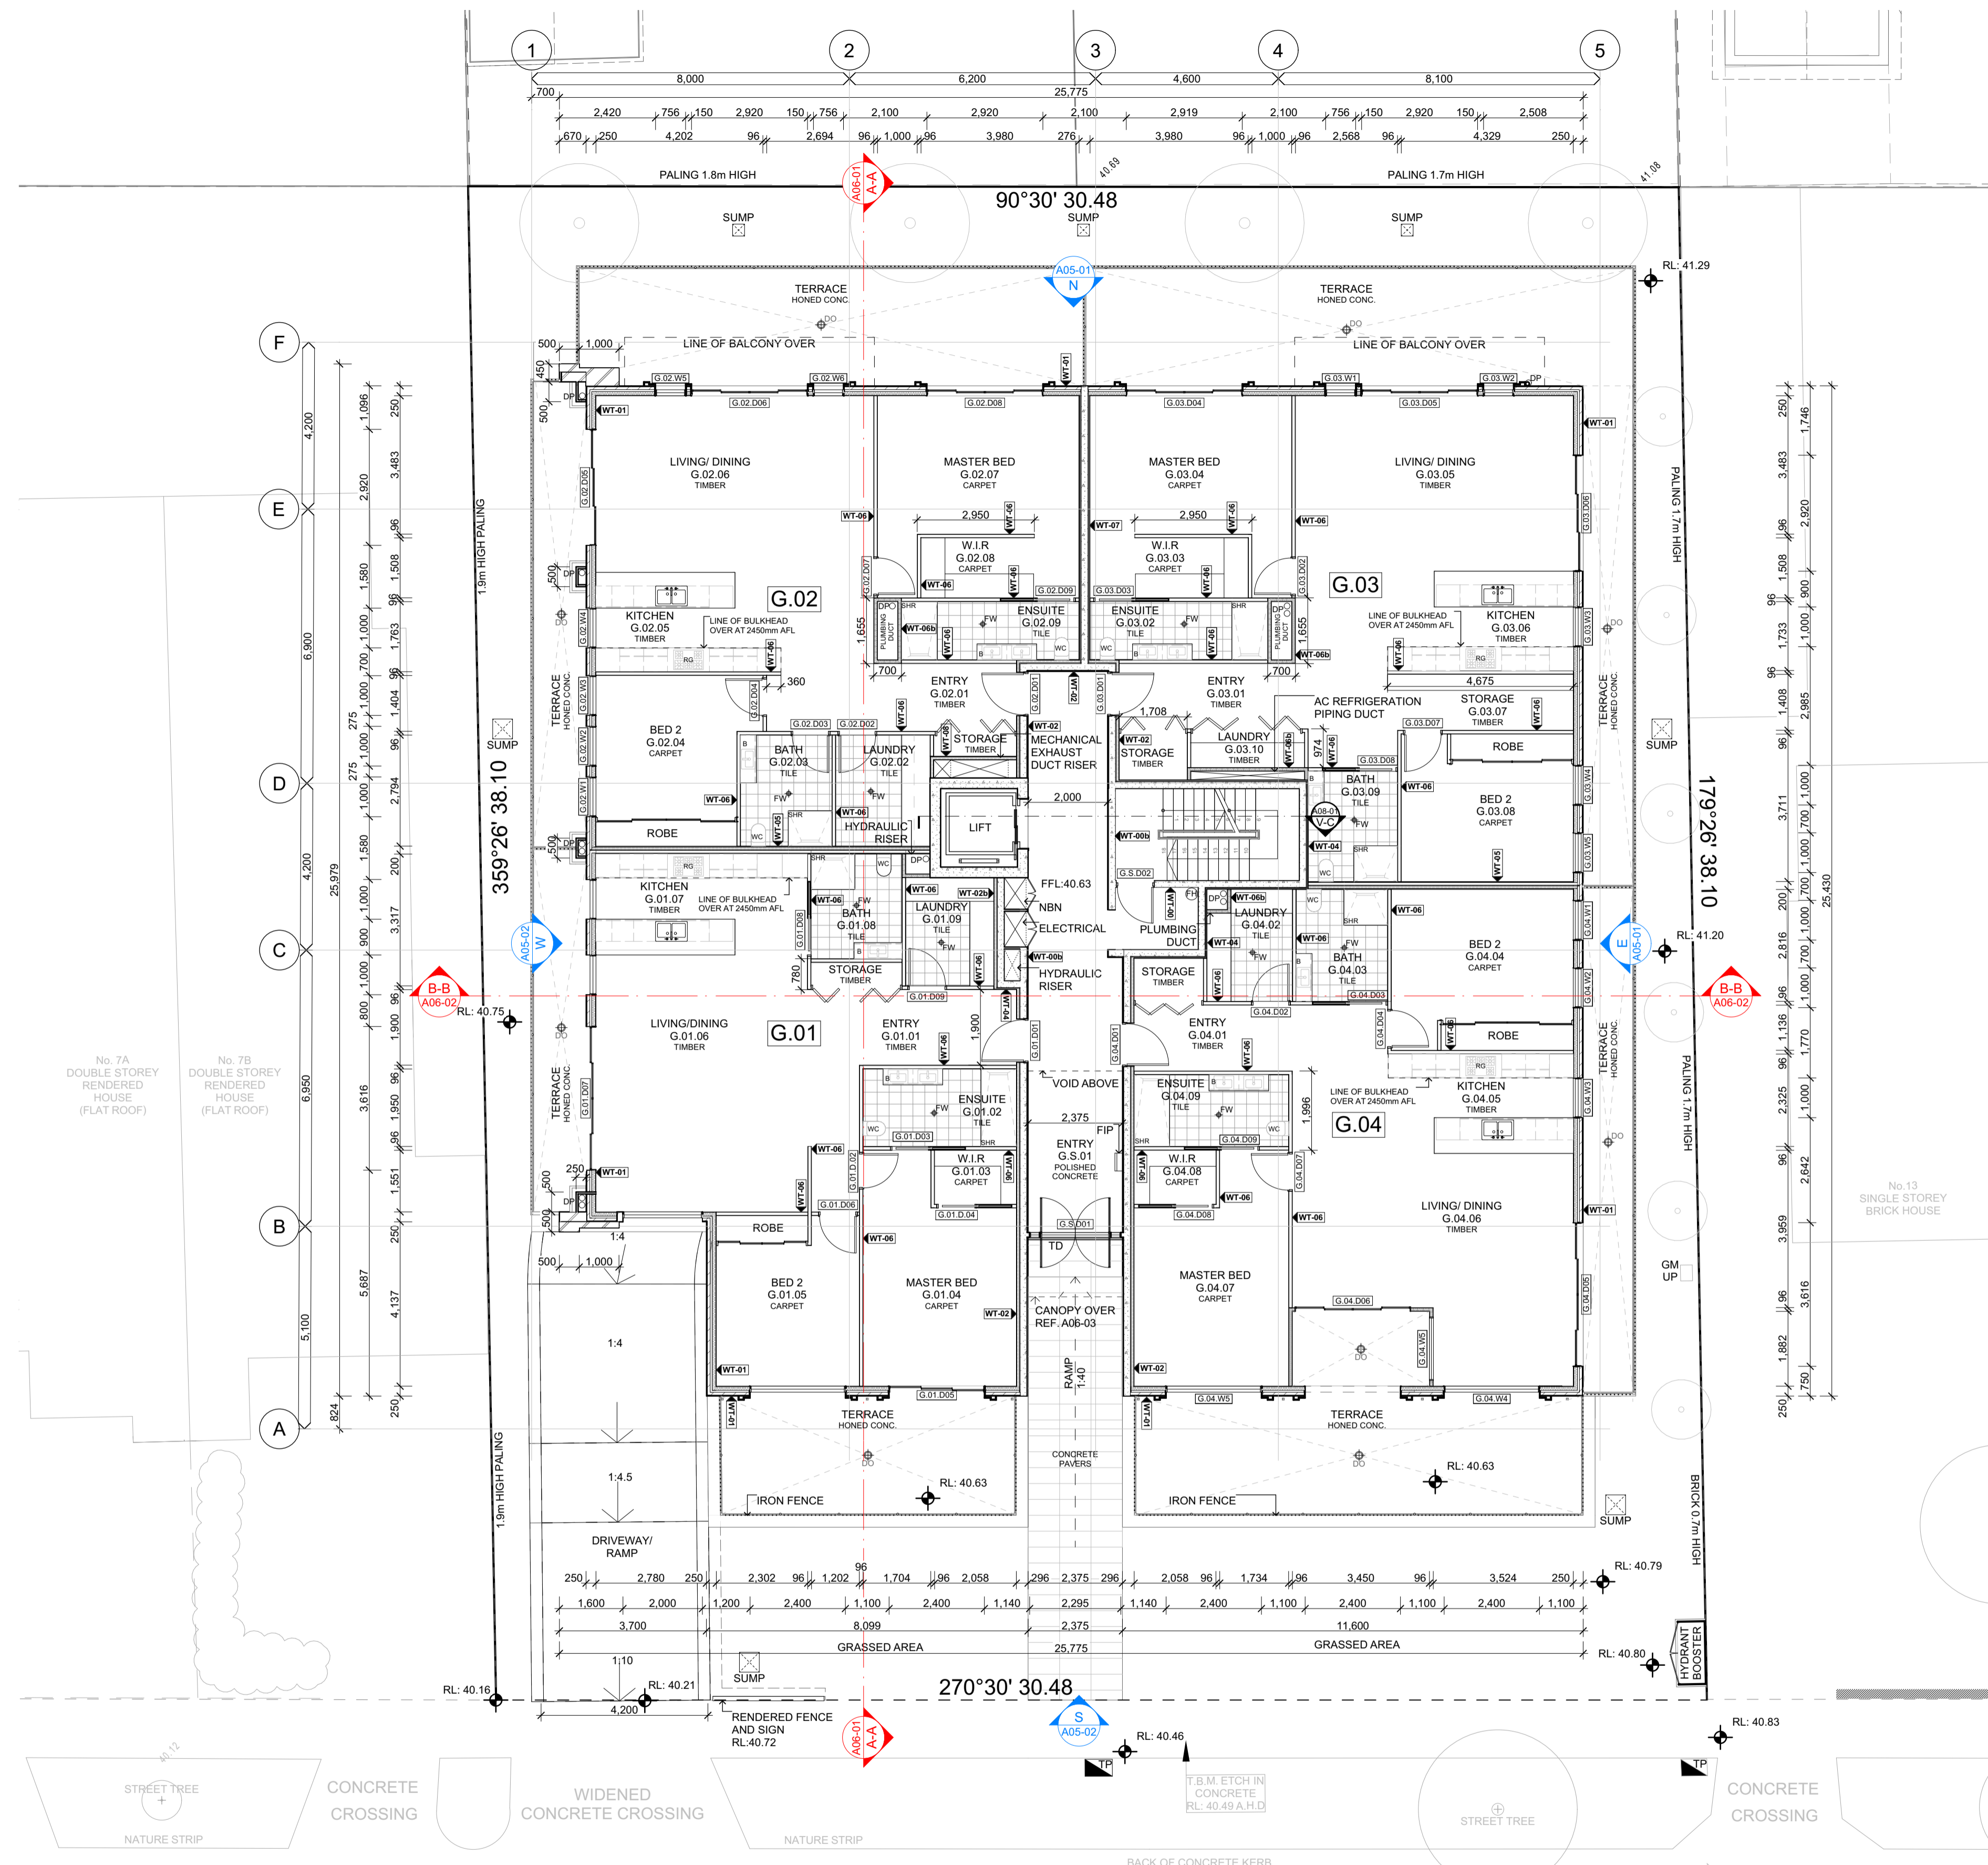


LEGEND	
DO	DRAINAGE OUTLET
DP	DOWNPIPE
FH	FIRE HYDRANT
FW	FLOOR WASTE
TD	THRESHOLD DRAIN
COL	COLUMN
FIP	FIRE INDICATOR PANEL
TP	TELSTRA PIT
RG	OVEN RANGE
WC	TOILET
SRH	SHOWER
B	BASIN

A02-02 GROUND FLOOR PLAN
1:100

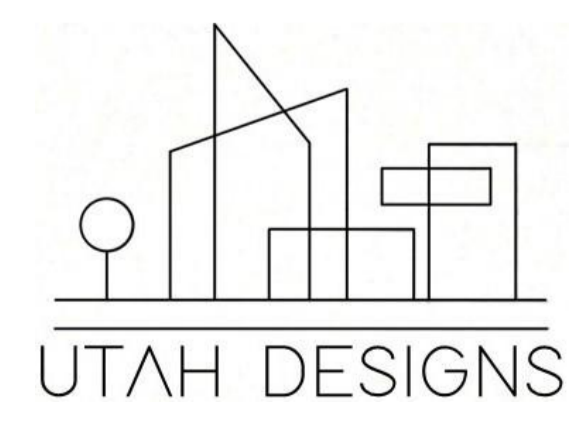

Rev	ChID	Description	Date
	P	PRELIMINARY SUBMISSION	8/05/26
	A	PRELIM (ADJUSTMENTS MADE FROM FEEDBACK)	15/05/26
	A	TR PRELIMINARY SUBMISSION	4/06/26
	B	FINAL SUBMISSION	12/06/26

NOTES:
 THE BUILDER SHALL CHECK AND VERIFY ALL DIMENSIONS AND NOTIFY ALL ERRORS AND OMISSIONS TO THE DESIGNER.
 DO NOT SCALE DRAWINGS.
 USE FIGURED DIMENSIONS ONLY. DRAWINGS ARE NOT TO BE USED FOR CONSTRUCTION UNTIL ISSUED BY THE DESIGNER FOR CONSTRUCTION.
 STUDENT DECLARES THAT THIS ASSESSMENT TASK IS HER/HIS OWN WORK UNLESS OTHERWISE ACKNOWLEDGED AND IS IN ACCORDANCE WITH THE INSTITUTE'S PLAGIARISM POLICY. STUDENT ACKNOWLEDGES THAT THE ASSESSOR OF THIS ASSESSMENT TASK MAY:
 1. REPRODUCE THIS ASSESSMENT TASK AND PROVIDE A COPY TO ANOTHER MEMBER OF THE INSTITUTE OR DISPLAY THIS ASSESSMENT WITHIN THE INSTITUTE FOR EDUCATIONAL PURPOSES. 2. SUBMIT THE ASSESSMENT TASK TO PLAGIARISM CHECKING.

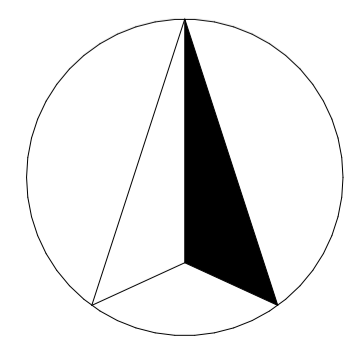

JAXON BELL
 100660344
 22477VIC
 Advanced Diploma of Building Design (Architectural)

holmesglen

AT4.2 APARTMENT BUILDING
 9-11 BEVIS STREET BENTLEIGH EAST
 VIC 3165 AUSTRALIA


DRAWING NAME:
 GROUND FLOOR PLAN

FILE: WD_AT4.2_APARTMENT BUILDING.pln

DATE: 14/06/2026 **CHECKED:** TEACHER


DWG NO: A02-02 **REVISION:** B

SCALE: 1:100 **at** A1

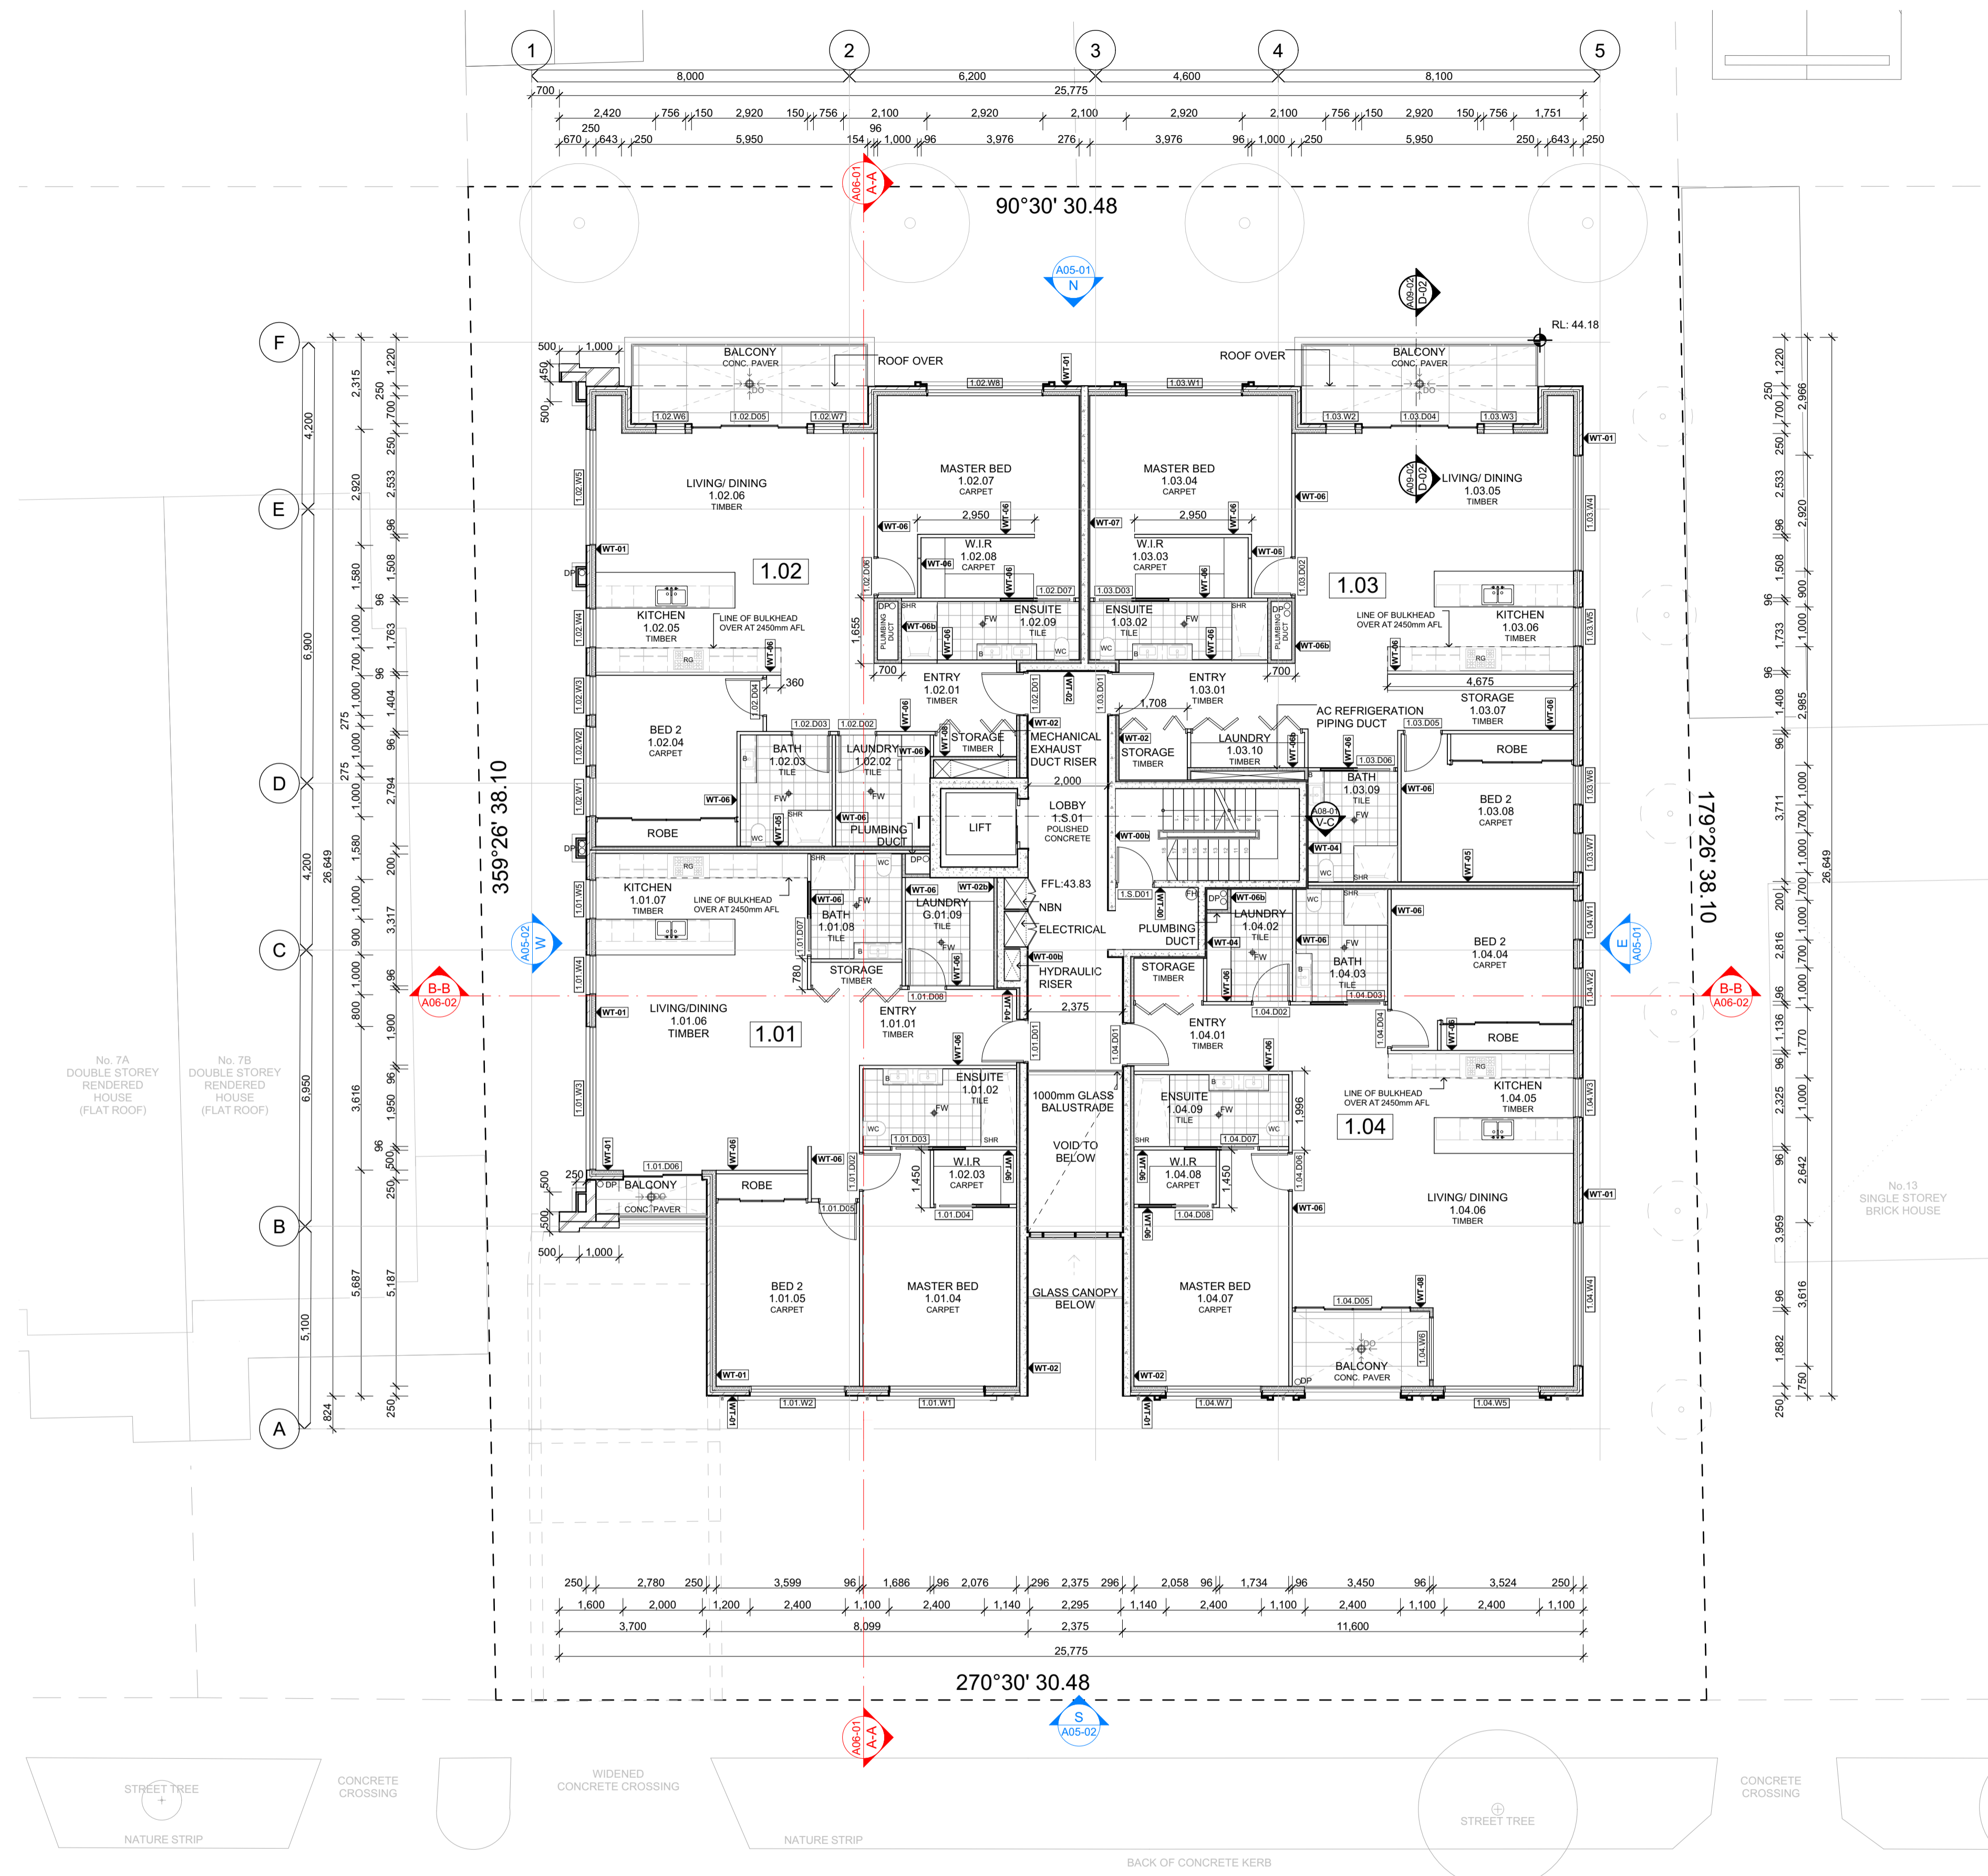

LEGEND	
DO	DRAINAGE OUTLET
DP	DOWNPIPE
FH	FIRE HYDRANT
FW	FLOOR WASTE
COL	COLUMN
RG	OVEN RANGE
WC	TOILET
SRH	SHOWER
B	BASIN


A02-03 **FIRST FLOOR PLAN**
1:100

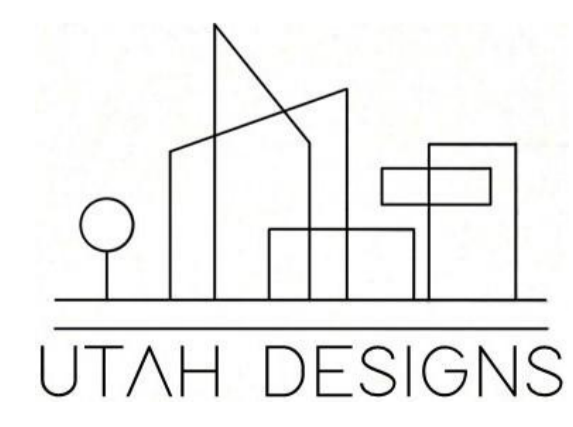

Rev	ChID	Description	Date
	P	PRELIMINARY SUBMISSION	15/05/26
	P	TR PRELIMINARY SUBMISSION	4/06/26
	A	FINAL SUBMISSION	12/06/26

NOTES:
THE BUILDER SHALL CHECK AND VERIFY ALL DIMENSIONS AND NOTIFY ALL ERRORS AND OMISSIONS TO THE DESIGNER.
DO NOT SCALE DRAWINGS.
USE FIGURED DIMENSIONS ONLY. DRAWINGS ARE NOT TO BE USED FOR CONSTRUCTION UNTIL ISSUED BY THE DESIGNER FOR CONSTRUCTION.

STUDENT DECLARES THAT THIS ASSESSMENT TASK IS HER/HIS OWN WORK UNLESS OTHERWISE ACKNOWLEDGED AND IS IN ACCORDANCE WITH THE INSTITUTE'S PLAGIARISM POLICY. STUDENT ACKNOWLEDGES THAT THE ASSESSOR OF THIS ASSESSMENT TASK MAY:
1. REPRODUCE THIS ASSESSMENT TASK AND PROVIDE A COPY TO ANOTHER MEMBER OF THE INSTITUTE OR DISPLAY THIS ASSESSMENT WITHIN THE INSTITUTE FOR EDUCATIONAL PURPOSES. 2. SUBMIT THE ASSESSMENT TASK TO PLAGIARISM CHECKING.

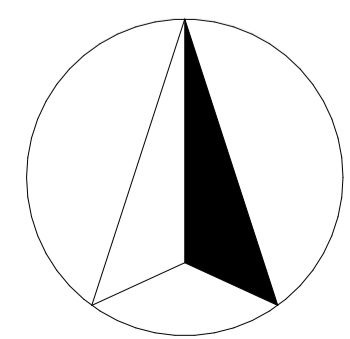

JAXON BELL
100660344
22477VIC
Advanced Diploma of Building Design (Architectural)

holmesglen

AT4.2 APARTMENT BUILDING
9-11 BEVIS STREET BENTLEIGH EAST
VIC 3165 AUSTRALIA


DRAWING NAME:
FIRST FLOOR PLAN

FILE: WD_AT4.2_APARTMENT BUILDING.pln

DATE: 14/06/2026 **CHECKED:** TEACHER


DWG NO: A02-03 **REVISION:** A

SCALE: 1:100 **at** A1

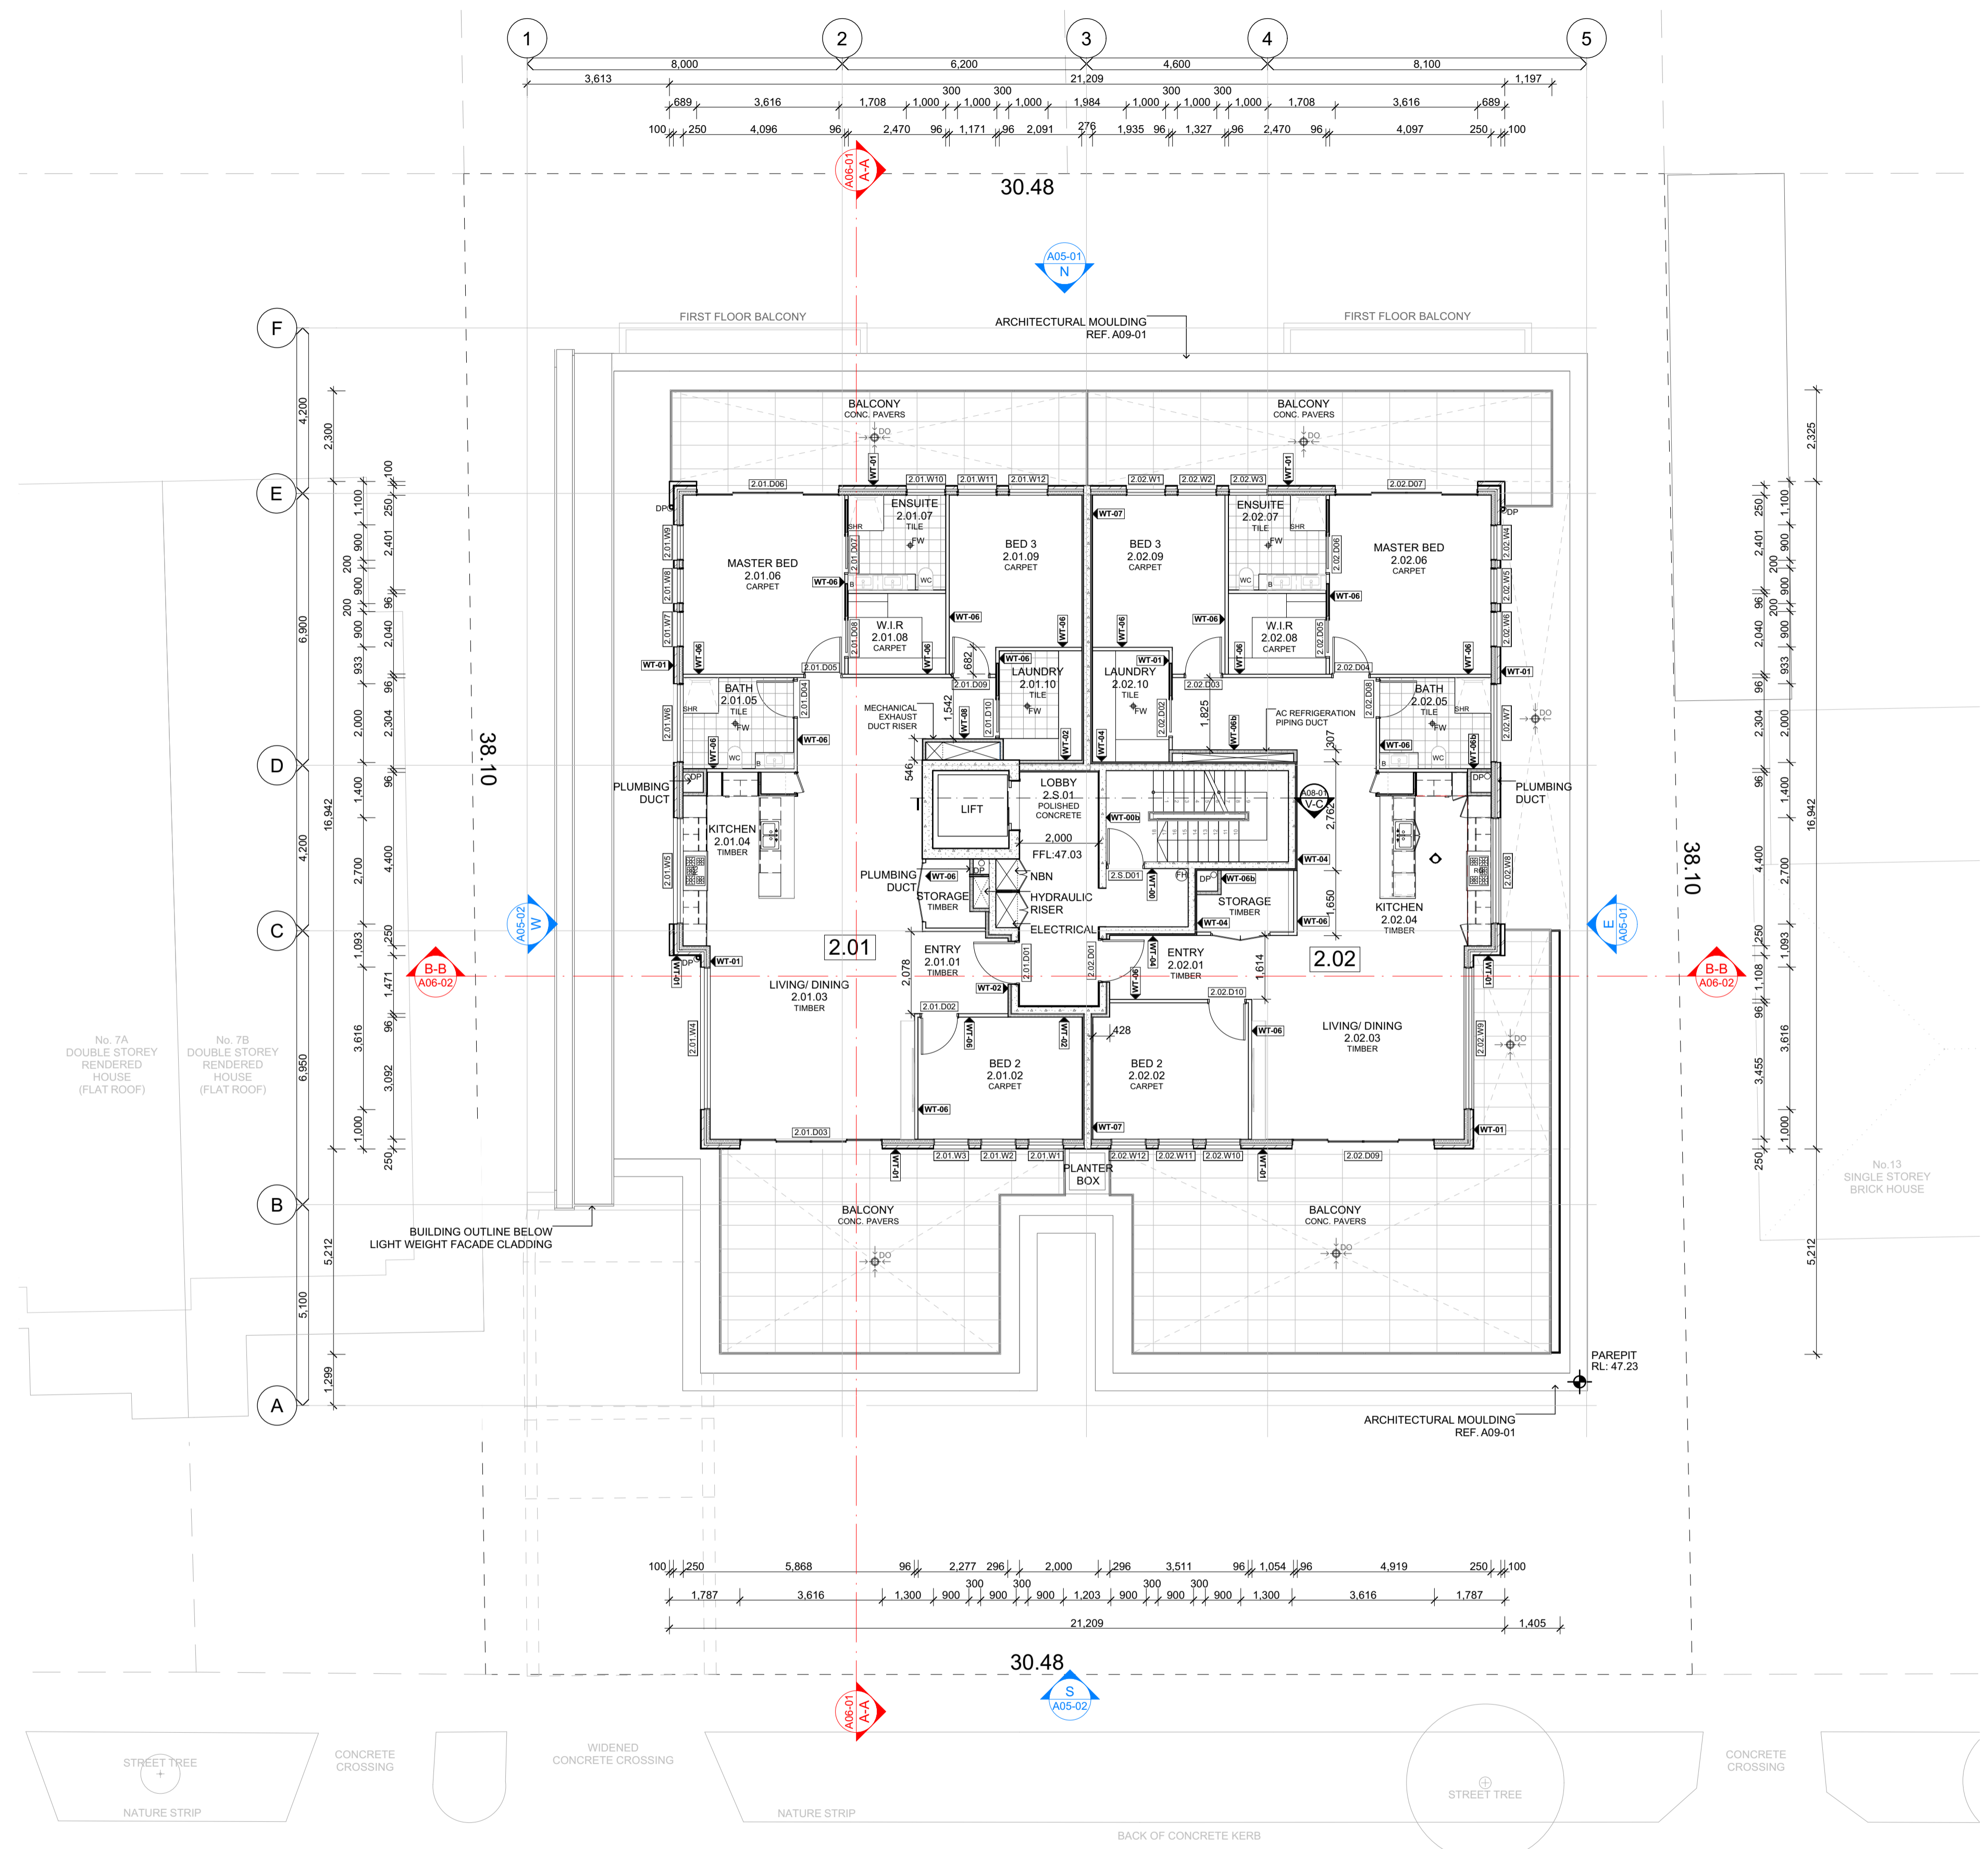


LEGEND	
DO	DRAINAGE OUTLET
DP	DOWNPIPE
FH	FIRE HYDRANT
FW	FLOOR WASTE
COL	COLUMN
RG	OVEN RANGE
WC	TOILET
SRH	SHOWER
B	BASIN

A02-04 SECOND FLOOR PLAN
1:100

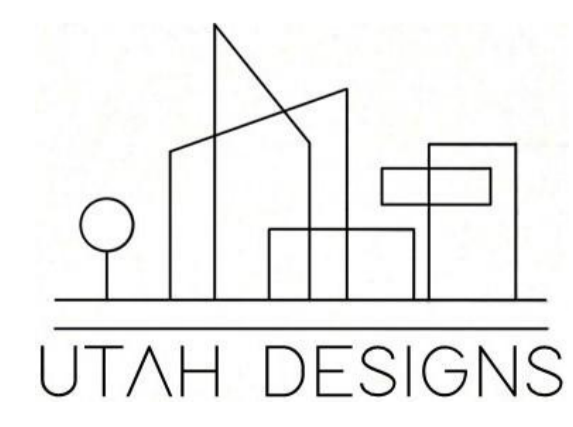

Rev	ChID	Description	Date
P		PRELIMINARY SUBMISSION	15/05/26
P		TR PRELIMINARY SUBMISSION	4/06/26
A	F	FINAL SUBMISSION	12/06/26

NOTES:
 THE BUILDER SHALL CHECK AND VERIFY ALL DIMENSIONS AND NOTIFY ALL ERRORS AND OMISSIONS TO THE DESIGNER.
 DO NOT SCALE DRAWINGS.
 USE FIGURED DIMENSIONS ONLY. DRAWINGS ARE NOT TO BE USED FOR CONSTRUCTION UNTIL ISSUED BY THE DESIGNER FOR CONSTRUCTION.
 STUDENT DECLARES THAT THIS ASSESSMENT TASK IS HER/HIS OWN WORK UNLESS OTHERWISE ACKNOWLEDGED AND IS IN ACCORDANCE WITH THE INSTITUTE'S PLAGIARISM POLICY. STUDENT ACKNOWLEDGES THAT THE ASSESSOR OF THIS ASSESSMENT TASK MAY:
 1. REPRODUCE THIS ASSESSMENT TASK AND PROVIDE A COPY TO ANOTHER MEMBER OF THE INSTITUTE OR DISPLAY THIS ASSESSMENT WITHIN THE INSTITUTE FOR EDUCATIONAL PURPOSES. 2. SUBMIT THE ASSESSMENT TASK TO PLAGIARISM CHECKING.

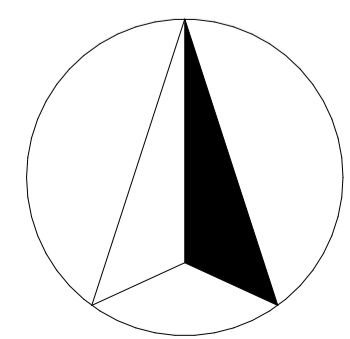

JAXON BELL
 100660344
 22477VIC
 Advanced Diploma of Building Design (Architectural)

holmesglen

AT4.2 APARTMENT BUILDING
 9-11 BEVIS STREET BENTLEIGH EAST
 VIC 3165 AUSTRALIA


DRAWING NAME:
 SECOND FLOOR PLAN

FILE: WD_AT4.2_APARTMENT BUILDING.pln


DATE: 14/06/2026 **CHECKED:** TEACHER

DWG NO: A02-04 **REVISION:** A

SCALE: 1:100 **at** A1

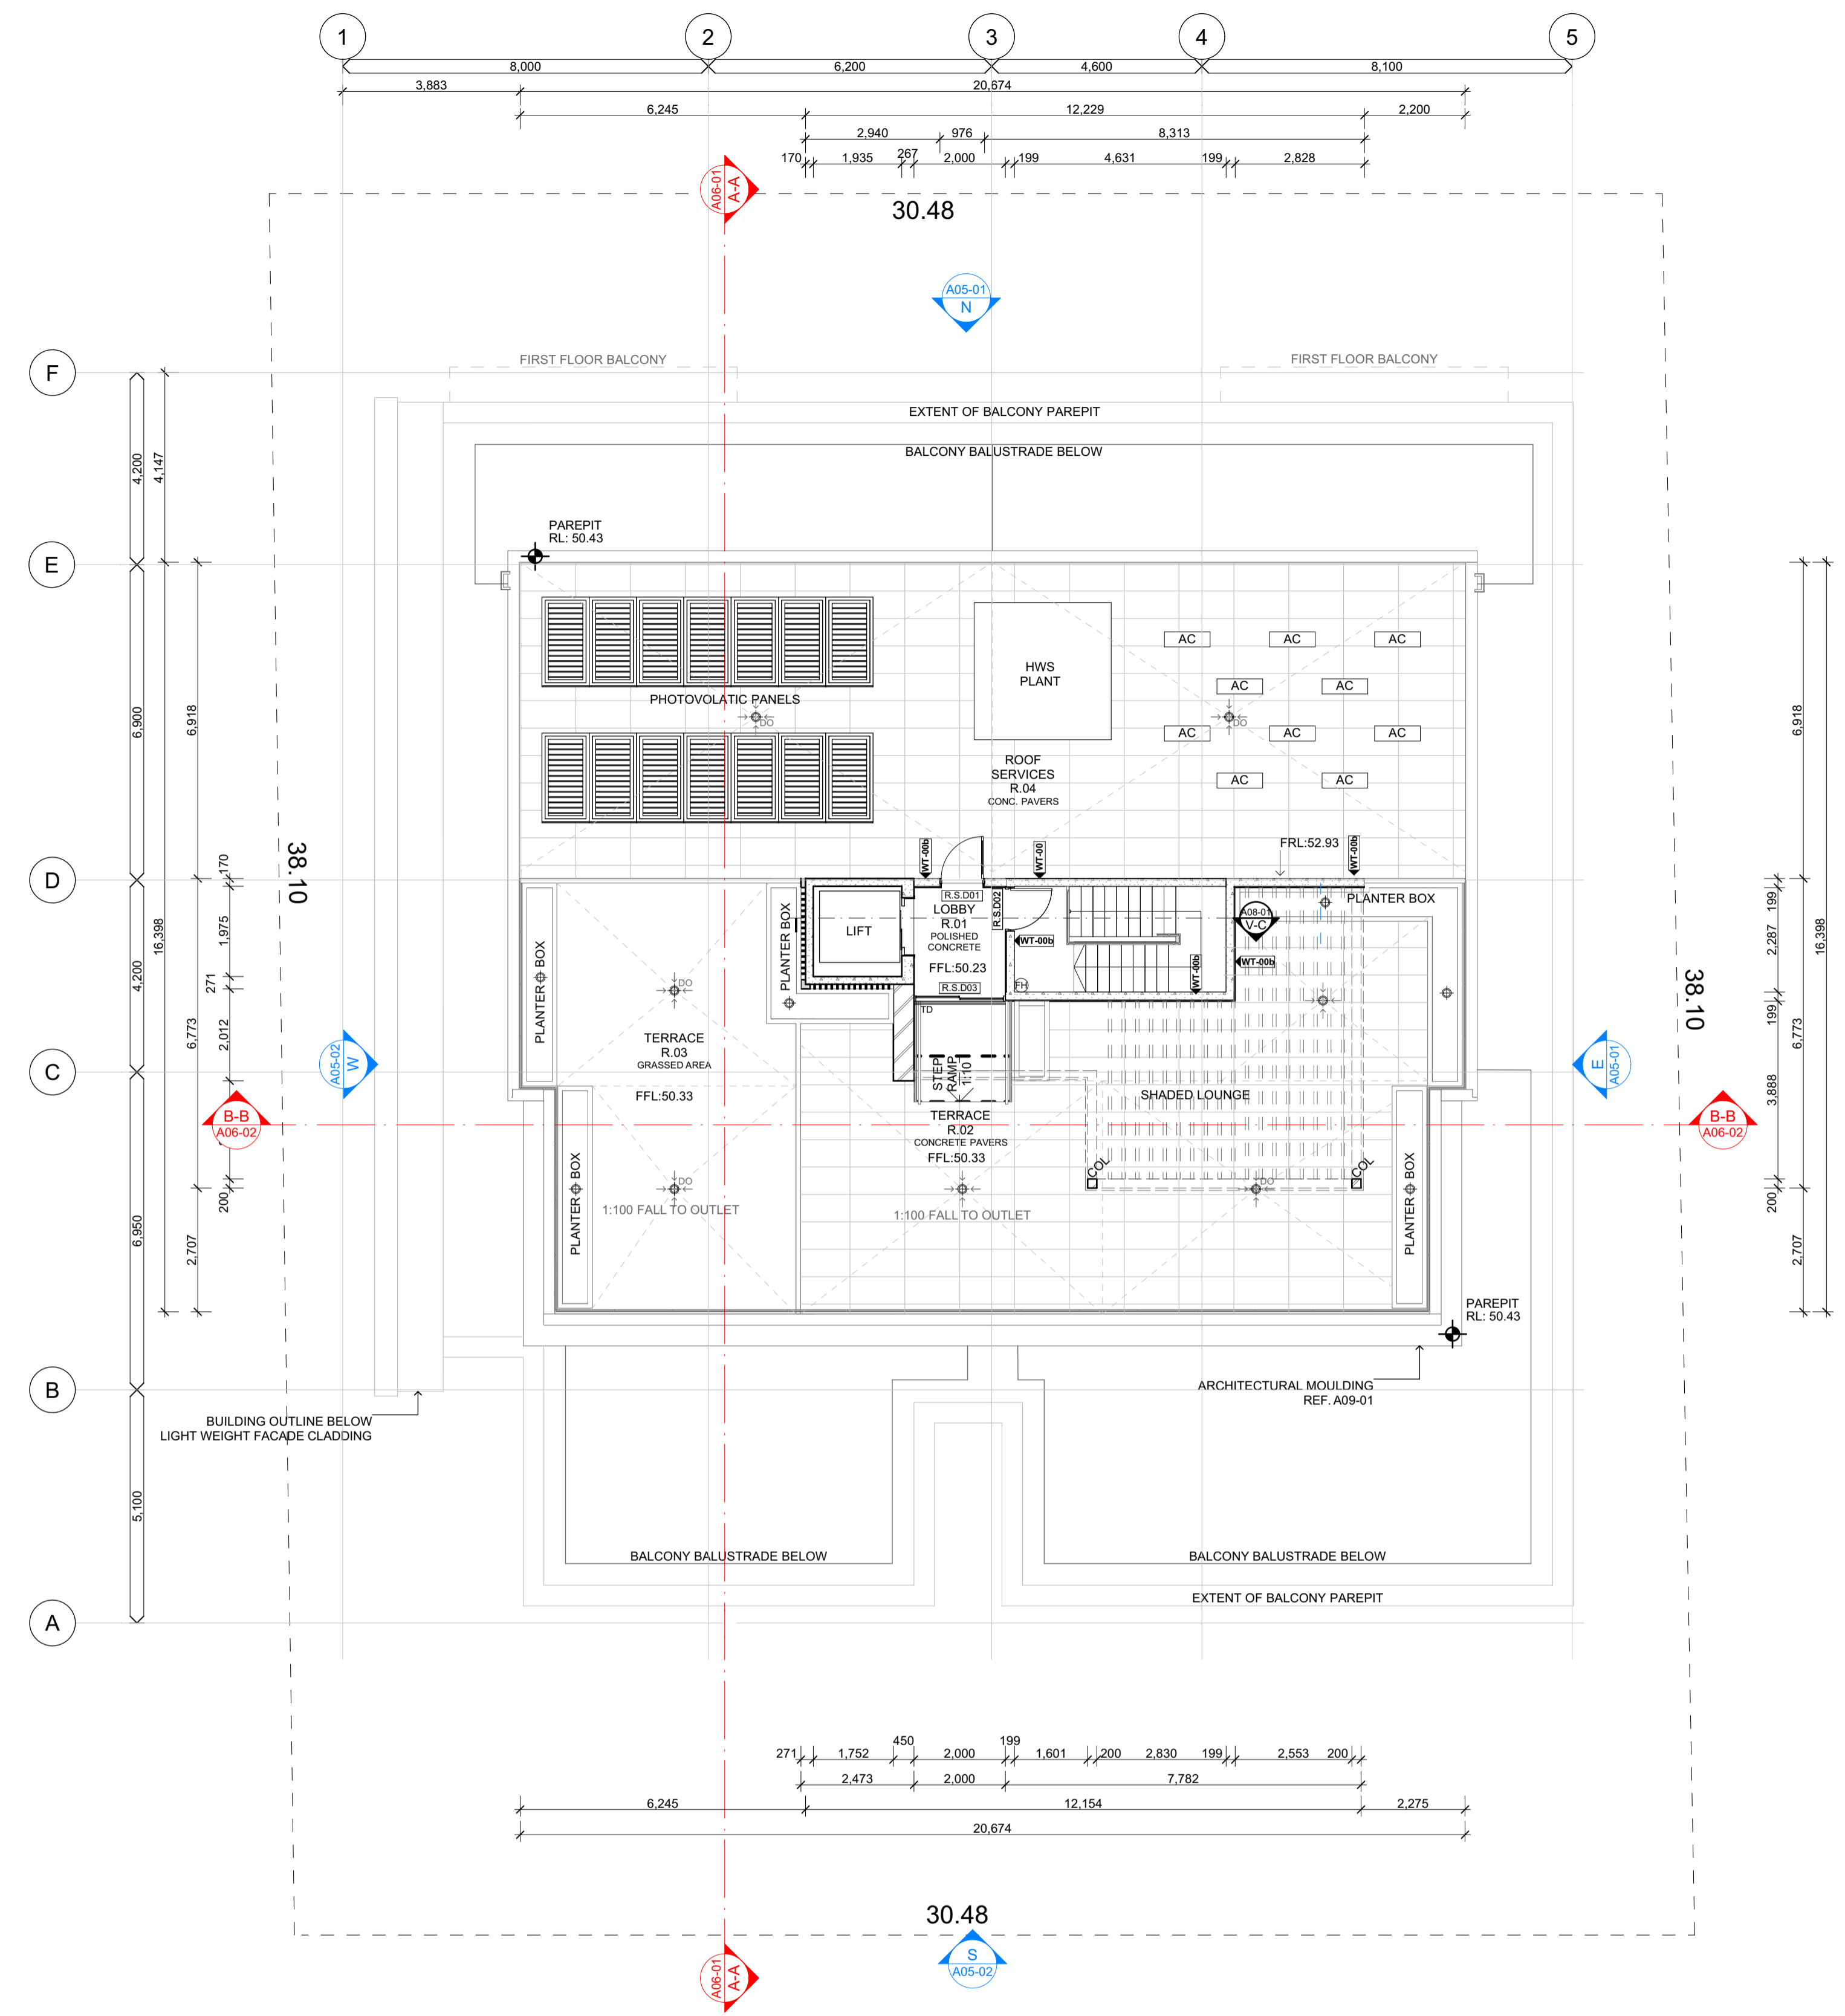


LEGEND	
DO	DRAINAGE OUTLET
DP	DOWNPIPE
TD	THRESHOLD DRAIN
FH	FIRE HYDRANT
FW	FLOOR WASTE
COL	COLUMN
RG	OVEN RANGE
WC	TOILET
SRH	SHOWER
B	BASIN

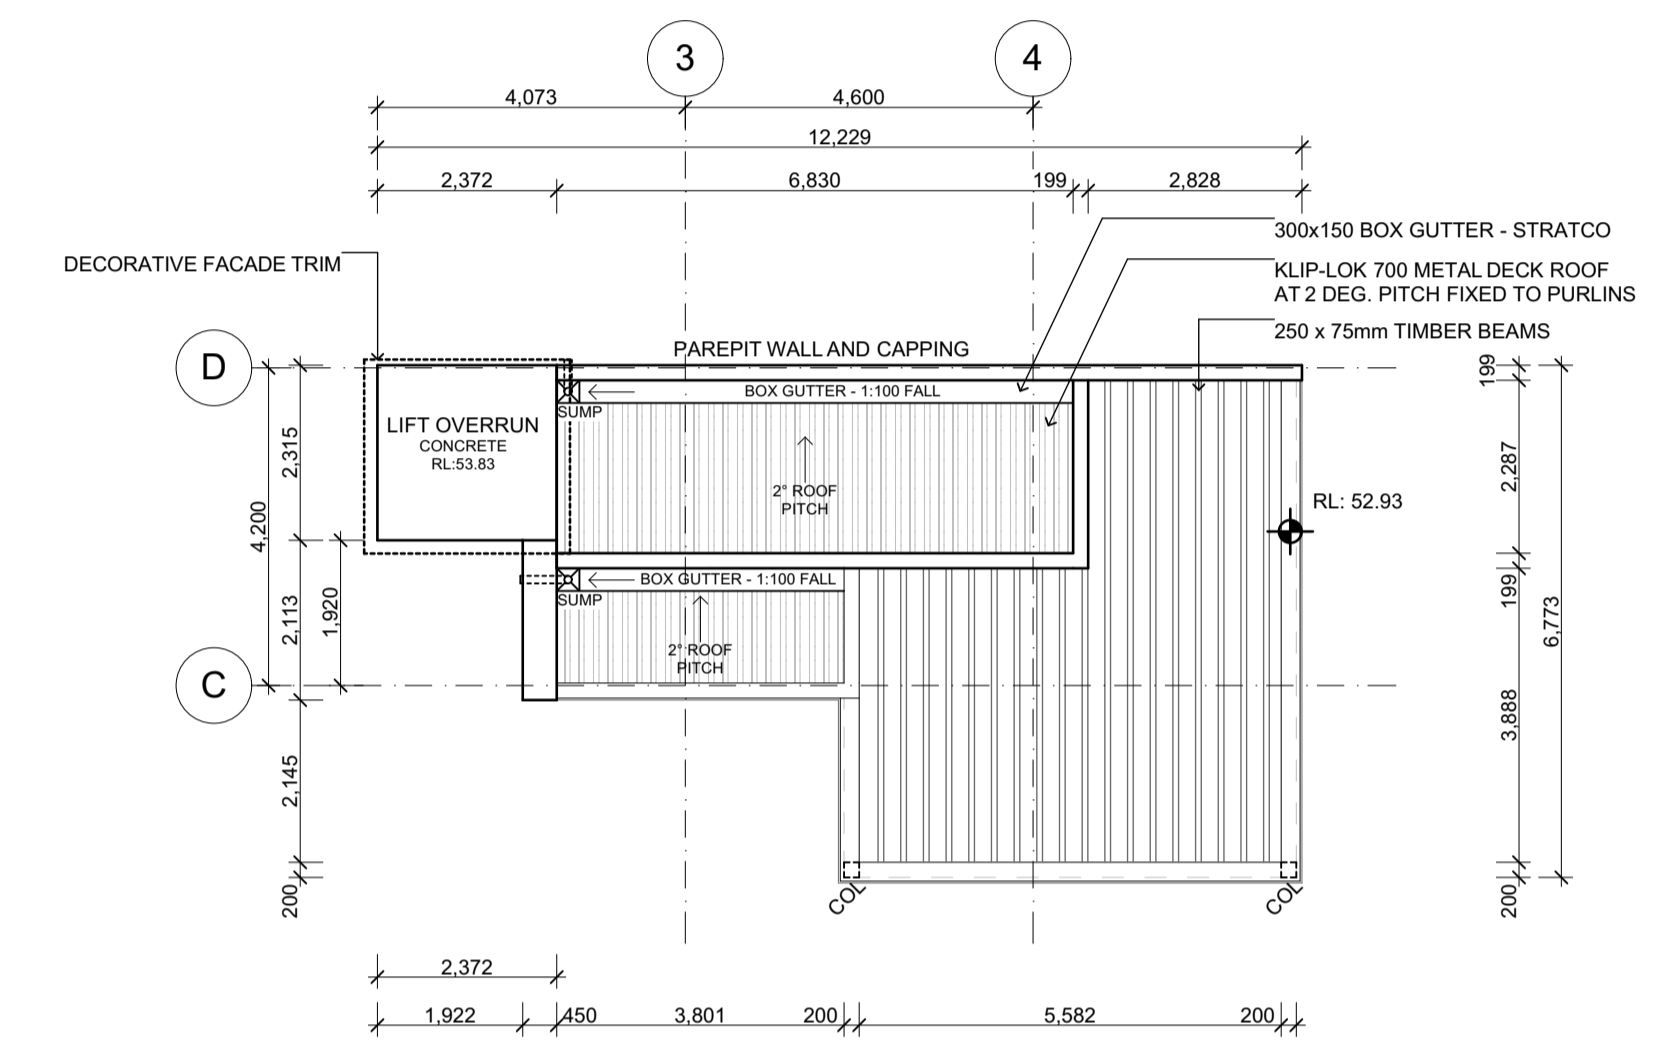

2 - ATRIUM ROOF 1:100


A02-05 ROOF PLAN 1:100

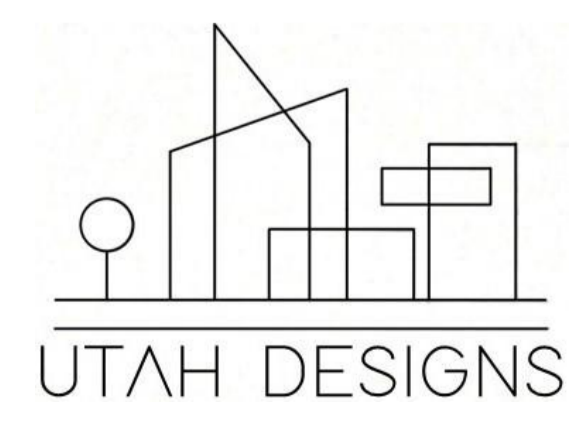

Rev	ChID	Description	Date
	P	PRELIMINARY SUBMISSION	15/05/26
A	P	PRELIM (ADJUSTMENTS MADE FROM FEEDBACK)	24/05/26
A	P	TR PRELIMINARY SUBMISSION	4/06/26
B	F	FINAL SUBMISSION	12/06/26

NOTES:
 THE BUILDER SHALL CHECK AND VERIFY ALL DIMENSIONS AND NOTIFY ALL ERRORS AND OMISSIONS TO THE DESIGNER.
 DO NOT SCALE DRAWINGS.
 USE FIGURED DIMENSIONS ONLY. DRAWINGS ARE NOT TO BE USED FOR CONSTRUCTION UNTIL ISSUED BY THE DESIGNER FOR CONSTRUCTION.

STUDENT DECLARES THAT THIS ASSESSMENT TASK IS HER/HIS OWN WORK UNLESS OTHERWISE ACKNOWLEDGED AND IS IN ACCORDANCE WITH THE INSTITUTE'S PLAGIARISM POLICY. STUDENT ACKNOWLEDGES THAT THE ASSESSOR OF THIS ASSESSMENT TASK MAY: 1. REPRODUCE THIS ASSESSMENT TASK AND PROVIDE A COPY TO ANOTHER MEMBER OF THE INSTITUTE OR DISPLAY THIS ASSESSMENT WITHIN THE INSTITUTE FOR EDUCATIONAL PURPOSES. 2. SUBMIT THE ASSESSMENT TASK TO PLAGIARISM CHECKING.

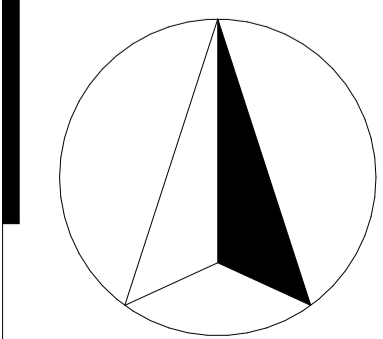

JAXON BELL
 100660344
 22477VIC
 Advanced Diploma of Building Design (Architectural)

holmesglen

AT4.2 APARTMENT BUILDING
 9-11 BEVIS STREET BENTLEIGH EAST
 VIC 3165 AUSTRALIA

DRAWING NAME:
 ROOF PLAN


FILE: WD_AT4.2_APARTMENT BUILDING.pln

DATE: 14/06/2026 **CHECKED:** TEACHER

DWG NO: A02-05 **REVISION:** B


SCALE: 1:100 **at** A1

ROOM SCHEDULE - LEVEL 1	
ROOM ID	ROOM NAME
G.S.01	ENTRY / LOBBY (COMMON AREA)
G.01.01	APARTMENT ENTRY
G.01.02	ENSUITE
G.01.03	WALK IN ROBE
G.01.04	MASTER BEDROOM
G.01.05	BEDROOM 2
G.01.06	OPEN LIVING / DINING
G.01.07	KITCHEN
G.01.08	BATHROOM
G.01.09	LAUNDRY
G.02.01	APARTMENT ENTRY
G.02.02	LAUNDRY
G.02.03	BATHROOM
G.02.04	BEDROOM 2
G.02.05	KITCHEN
G.02.06	OPEN LIVING / DINING
G.02.07	MASTER BEDROOM
G.02.08	WALK IN ROBE
G.02.09	ENSUITE
G.02.01	APARTMENT ENTRY
G.02.02	ENSUITE
G.02.03	WALK IN ROBE
G.02.04	MASTER BEDROOM
G.02.05	OPEN LIVING / DINING
G.02.06	KITCHEN
G.02.07	STORAGE
G.02.08	BEDROOM 2
G.02.09	BATHROOM
G.02.10	LAUNDRY
G.02.01	APARTMENT ENTRY
G.02.02	LAUNDRY
G.02.03	BATHROOM
G.02.04	BEDROOM 2
G.02.05	KITCHEN
G.02.06	OPEN LIVING / DINING
G.02.07	MASTER BEDROOM
G.02.08	WALK IN ROBE
G.02.09	ENSUITE

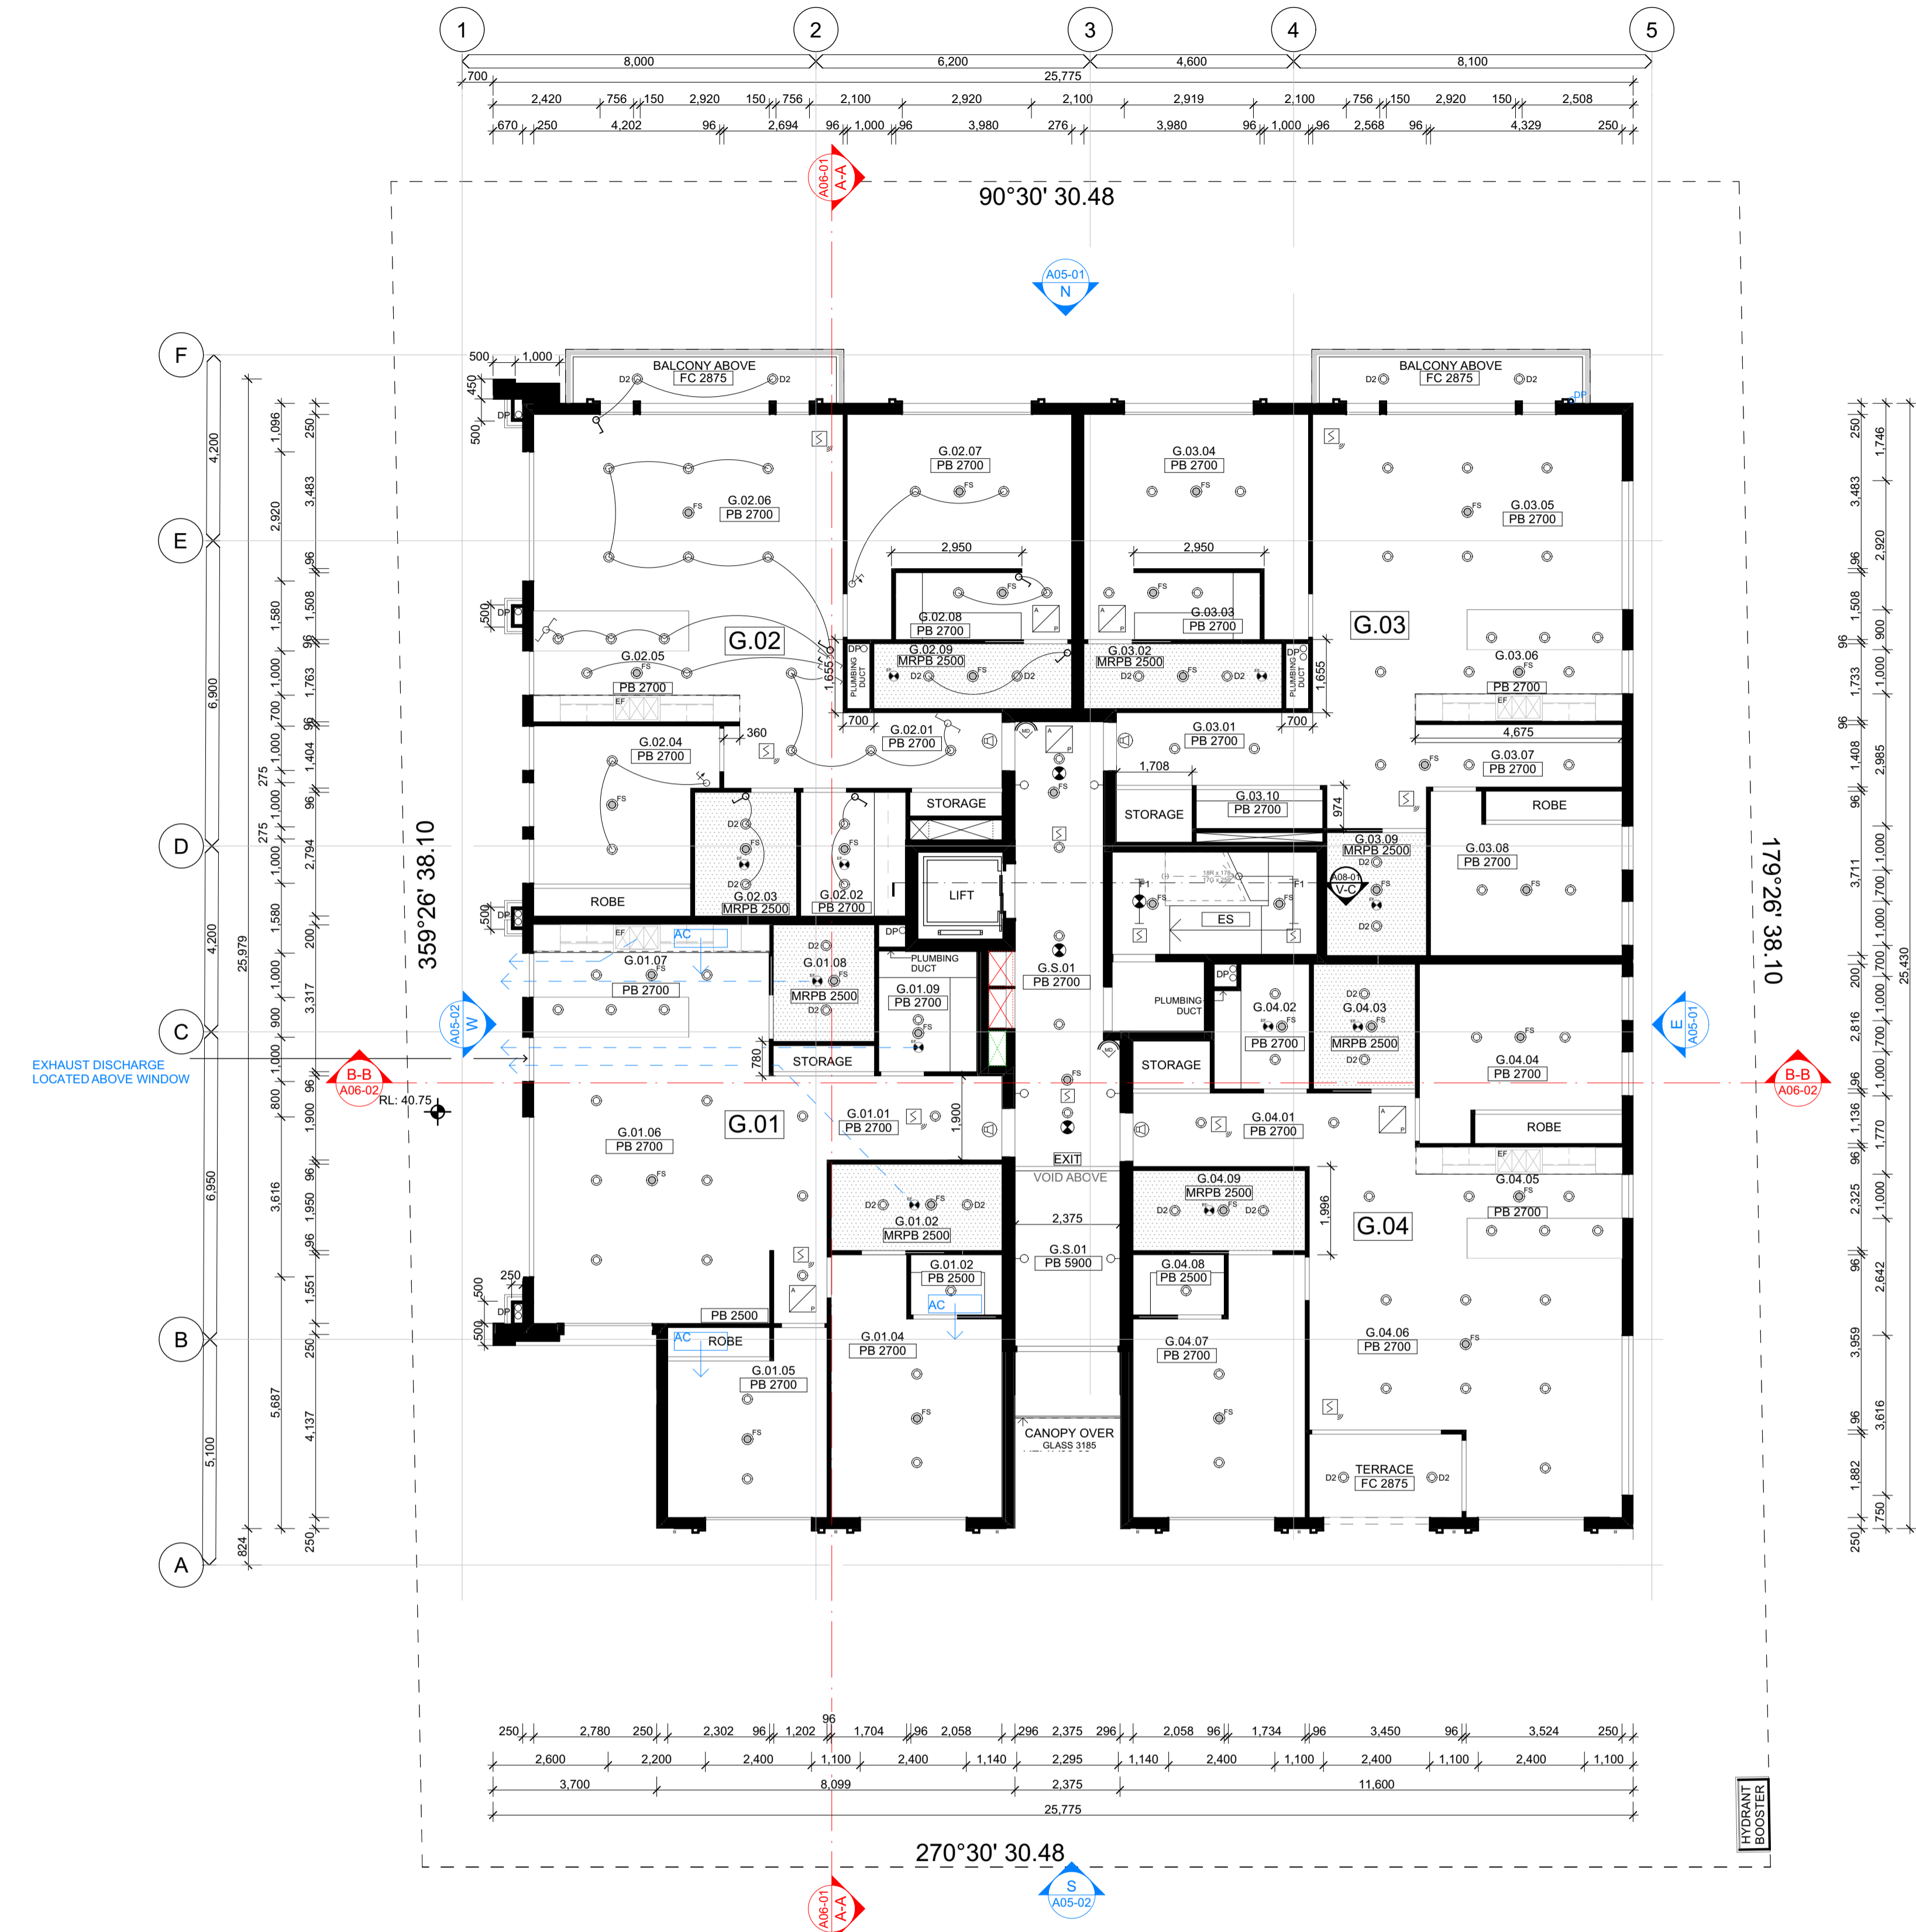


LEGEND - RCP SYMBOLS	
DP	DOWNPIPE
FH	FIRE HYDRANT
EF	EXHAUST FAN
	RECESSED LED DOWNLIGHT
D2	IP44 RECESSED LED DOWNLIGHT - BATHROOMS & EXTERNAL
	EXTERIOR WALL MOUNTED LIGHT
F1	IP66 32W (3200LM) LED DIFFUSED BATTEN
	CEILING RECESSED EMERGENCY LUMINAIRE
	SMOKE DETECTOR TO AS 1670
	RESIDENTIAL SMOKE DETECTOR TO AS 1670
	CEILING FLUSH MOUNTED LOUDSPEAKER
FS	FIRE SPRINKLER
EXIT	EXIT SIGN
A	CEILING ACCESS PANEL
	ONE WAY SWITCH
	TWO WAY SWITCH
	DIMMER LIGHT SWITCH
PB 0000	FLUSH PLASTERBOARD AT HEIGHT AS SHOWN
MRPB 0000	MOISTURE RESISTANT FLUSH PLASTERBOARD AT HEIGHT AS SHOWN
FC 0000	FIBRE CEMENT SHEET AT HEIGHT AS SHOWN
ES	EXPOSED CEILING / STRUCTURE

A04-01 GROUND FLOOR REFLECTED CEILING PLAN
1:100

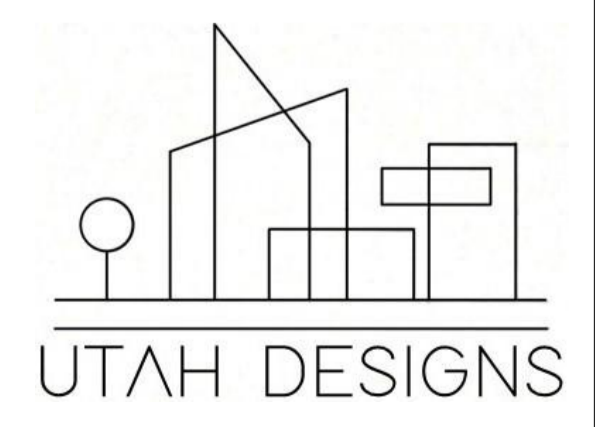

Rev	ChID	Description	Date
	P	PRELIMINARY SUBMISSION	29/05/26
	P	TR PRELIMINARY SUBMISSION	4/06/26
	A	FINAL SUBMISSION	12/06/26

NOTES:
 THE BUILDER SHALL CHECK AND VERIFY ALL DIMENSIONS AND NOTIFY ALL ERRORS AND OMISSIONS TO THE DESIGNER.
 DO NOT SCALE DRAWINGS.
 USE FIGURED DIMENSIONS ONLY. DRAWINGS ARE NOT TO BE USED FOR CONSTRUCTION UNTIL ISSUED BY THE DESIGNER FOR CONSTRUCTION.
 STUDENT DECLARES THAT THIS ASSESSMENT TASK IS HER/HIS OWN WORK UNLESS OTHERWISE ACKNOWLEDGED AND IS IN ACCORDANCE WITH THE INSTITUTE'S PLAGIARISM POLICY. STUDENT ACKNOWLEDGES THAT THE ASSESSOR OF THIS ASSESSMENT TASK MAY: 1. REPRODUCE THIS ASSESSMENT TASK AND PROVIDE A COPY TO ANOTHER MEMBER OF THE INSTITUTE OR DISPLAY THIS ASSESSMENT WITHIN THE INSTITUTE FOR EDUCATIONAL PURPOSES. 2. SUBMIT THE ASSESSMENT TASK TO PLAGIARISM CHECKING.

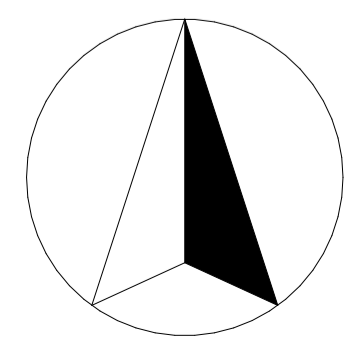

JAXON BELL
 100660344
 22477VIC
 Advanced Diploma of Building Design (Architectural)

holmesglen

AT4.2 APARTMENT BUILDING
 9-11 BEVIS STREET BENTLEIGH EAST
 VIC 3165 AUSTRALIA


DRAWING NAME:
 RCP - GROUND FLOOR

FILE: WD_AT4.2_APARTMENT BUILDING.pln

DATE: 14/06/2026 **CHECKED:** TEACHER

DWG NO: A04-01 **REVISION:** A


SCALE: 1:100 **at** A1

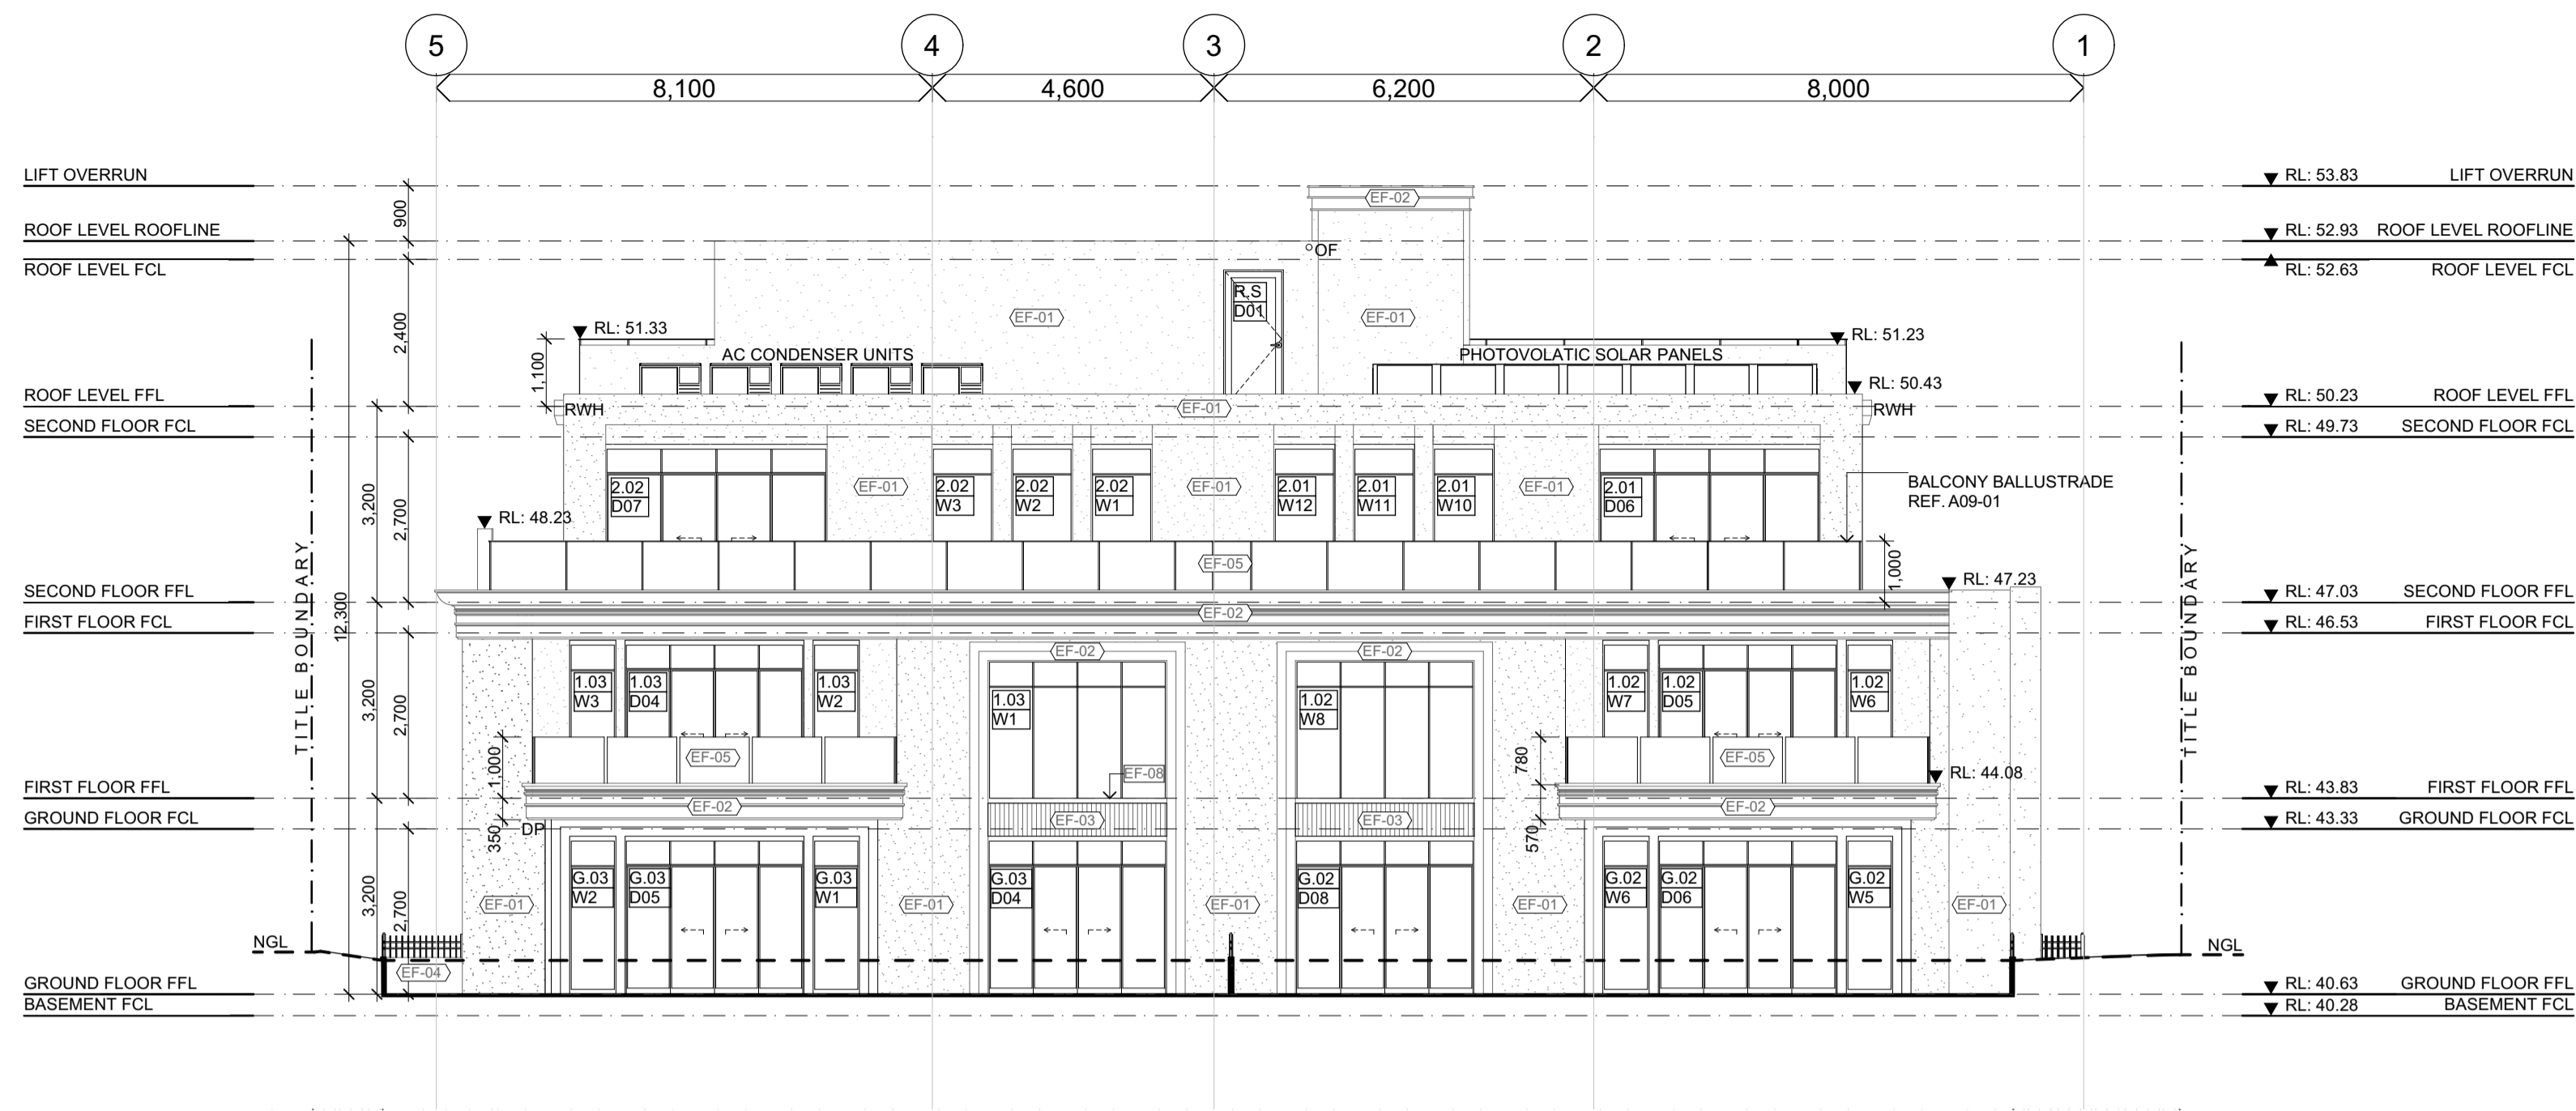


N
A02-01
NORTH ELEVATION

LEGEND	
DP	DOWNPIPE
RWH	RAINWATER HEAD
OF	OVERFLOW
AG	ARCHITECTURAL GRILLE - REF. MECH' DRG'S FOR SIZING

EXTERNAL FINISHES	
EF-01	CSR 20mm STONE PANELS - SANDSTONE FINISH
EF-02	CEMENT SHEET & MOULDINGS - WHITE RENDER FINISH
EF-03	FLUTED CONCRETE PANEL - LIGHT BROWN FINISH
EF-04	CONCRETE FACADE TILES - GRAY FINISH (ROUGH)
EF-05	BALLUSTRADE GLAZING - CLEAR
EF-06	TIMBER - DARK OAK
EF-07	ALUMINIUM LOUVRE GRILLE - POWDER COAT TO MATCH EF-01

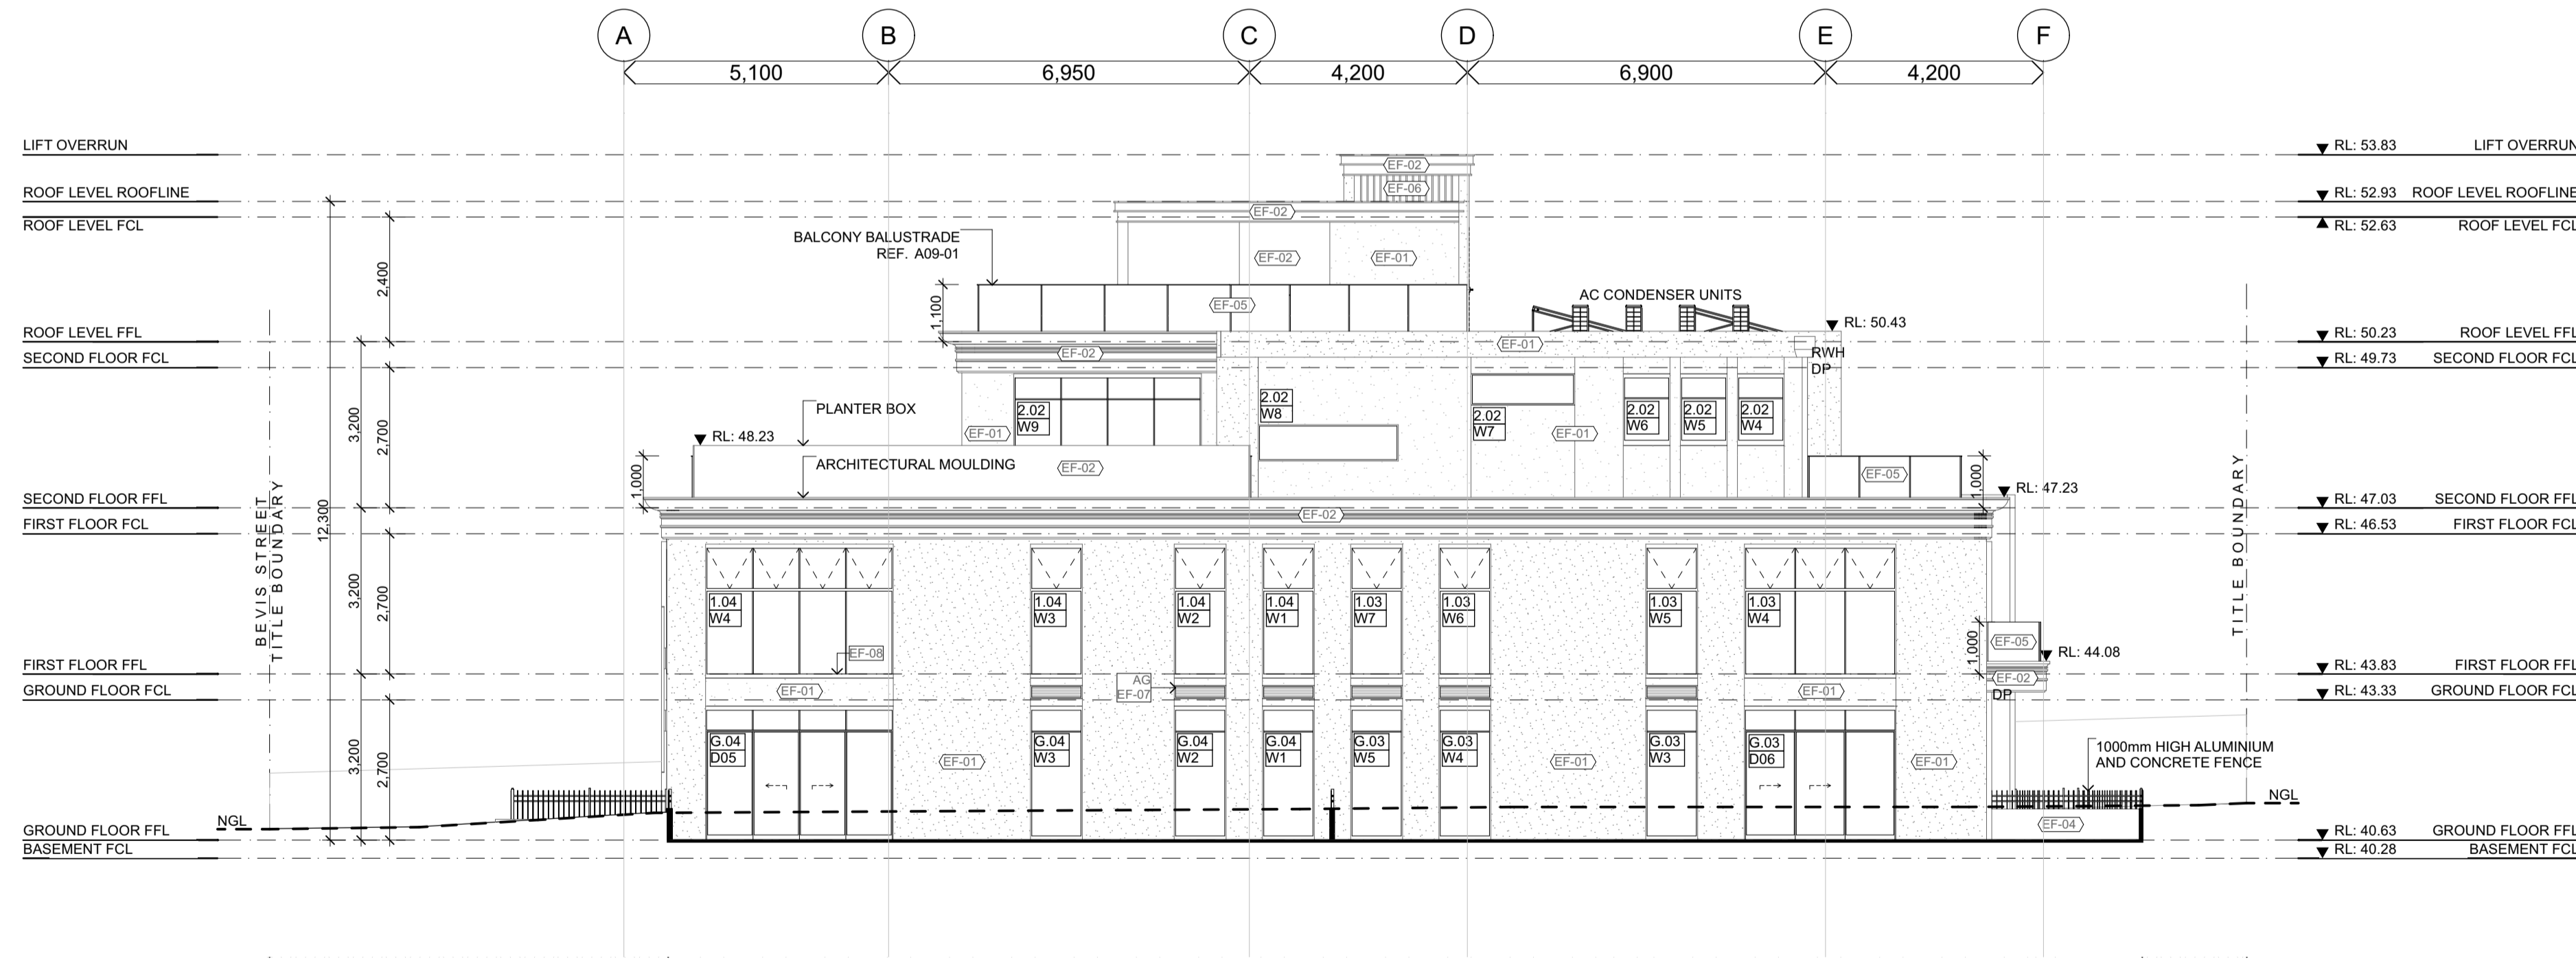

E
A02-01
EAST ELEVATION

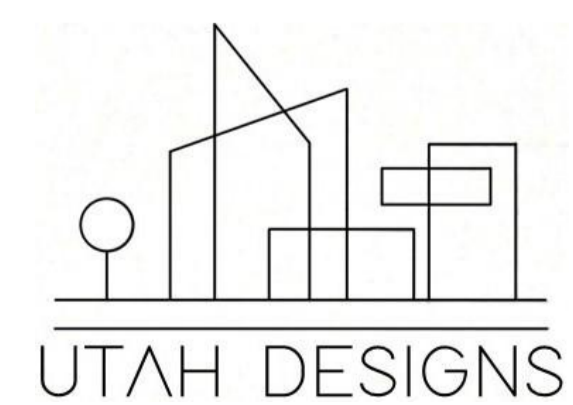

Rev	ChID	Description	Date
P		PRELIMINARY SUBMISSION	22/05/26
P		TR PRELIMINARY SUBMISSION	4/06/26
A		FINAL SUBMISSION	12/06/26

NOTES:
 THE BUILDER SHALL CHECK AND VERIFY ALL DIMENSIONS AND NOTIFY ALL ERRORS AND OMISSIONS TO THE DESIGNER.
 DO NOT SCALE DRAWINGS.
 USE FIGURED DIMENSIONS ONLY. DRAWINGS ARE NOT TO BE USED FOR CONSTRUCTION UNTIL ISSUED BY THE DESIGNER FOR CONSTRUCTION.
 STUDENT DECLARES THAT THIS ASSESSMENT TASK IS HER/HIS OWN WORK UNLESS OTHERWISE ACKNOWLEDGED AND IS IN ACCORDANCE WITH THE INSTITUTE'S PLAGIARISM POLICY. STUDENT ACKNOWLEDGES THAT THE ASSESSOR OF THIS ASSESSMENT TASK MAY:
 1. REPRODUCE THIS ASSESSMENT TASK AND PROVIDE A COPY TO ANOTHER MEMBER OF THE INSTITUTE OR DISPLAY THIS ASSESSMENT WITHIN THE INSTITUTE FOR EDUCATIONAL PURPOSES. 2. SUBMIT THE ASSESSMENT TASK TO PLAGIARISM CHECKING.

JAXON BELL
 100660344
 22477VIC
 Advanced Diploma of Building Design (Architectural)

AT4.2 APARTMENT BUILDING
 9-11 BEVIS STREET BENTLEIGH EAST
 VIC 3165 AUSTRALIA

DRAWING NAME:
 ELEVATIONS - NORTH, EAST
FILE: WD_AT4.2_APARTMENT BUILDING.pln
DATE: 14/06/2026
CHECKED: TEACHER


DWG NO: A05-01
REVISION: A
SCALE: 1:100 at A1




LEGEND	
DP	DOWNPIPE
RWH	RAINWATER HEAD
OF	OVERFLOW
AG	ARCHITECTURAL GRILLE - REF. MECH' DRG'S FOR SIZING
FHB	FIRE HYDRANT BOOSTER

EXTERNAL FINISHES	
EF-01	CSR 20mm STONE PANELS - SANDSTONE FINISH
EF-02	CEMENT SHEET & MOULDINGS - WHITE RENDER FINISH
EF-03	FLUTED CONCRETE PANEL - LIGHT BROWN FINISH
EF-04	CONCRETE FACADE TILES - GRAY FINISH (ROUGH)
EF-05	BALLUSTRADE GLAZING - CLEAR
EF-06	TIMBER - DARK OAK
EF-07	ALUMINIUM LOUVRE GRILLE - POWDER COAT TO MATCH EF-01

S
A02-01 SOUTH ELEVATION

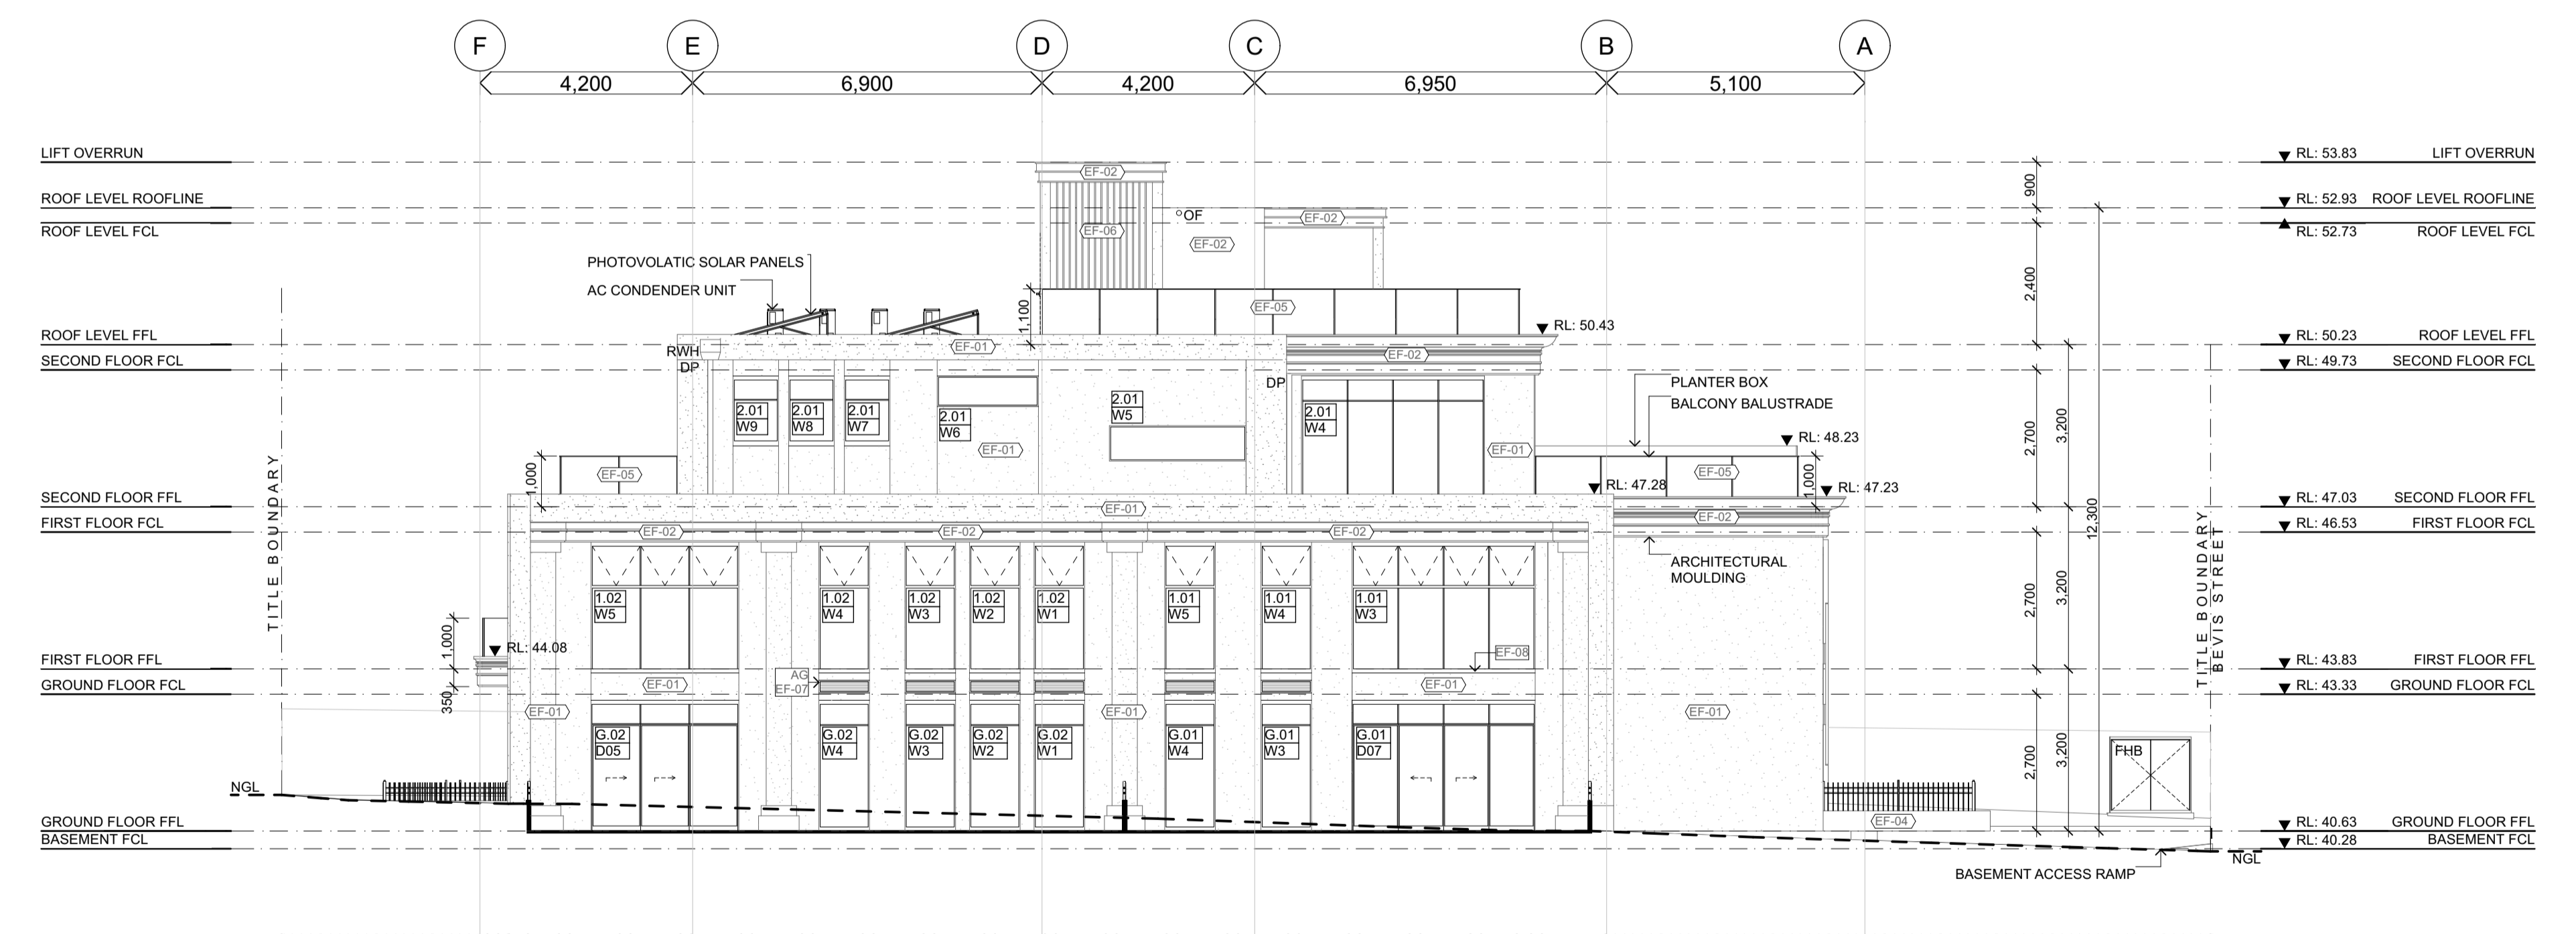

W
A02-01 WEST ELEVATION

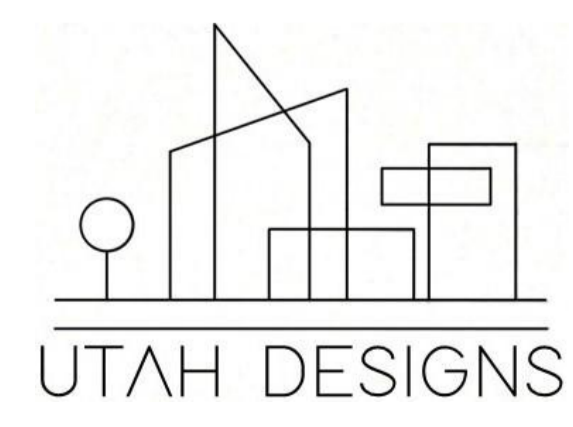

Rev	ChID	Description	Date
P		PRELIMINARY SUBMISSION	22/05/26
P		TR PRELIMINARY SUBMISSION	4/06/26
A	F	FINAL SUBMISSION	12/06/26

NOTES:
 THE BUILDER SHALL CHECK AND VERIFY ALL DIMENSIONS AND NOTIFY ALL ERRORS AND OMISSIONS TO THE DESIGNER.
 DO NOT SCALE DRAWINGS.
 USE FIGURED DIMENSIONS ONLY. DRAWINGS ARE NOT TO BE USED FOR CONSTRUCTION UNTIL ISSUED BY THE DESIGNER FOR CONSTRUCTION.
 STUDENT DECLARES THAT THIS ASSESSMENT TASK IS HER/HIS OWN WORK UNLESS OTHERWISE ACKNOWLEDGED AND IS IN ACCORDANCE WITH THE INSTITUTE'S PLAGIARISM POLICY. STUDENT ACKNOWLEDGES THAT THE ASSESSOR OF THIS ASSESSMENT TASK MAY:
 1. REPRODUCE THIS ASSESSMENT TASK AND PROVIDE A COPY TO ANOTHER MEMBER OF THE INSTITUTE OR DISPLAY THIS ASSESSMENT WITHIN THE INSTITUTE FOR EDUCATIONAL PURPOSES. 2. SUBMIT THE ASSESSMENT TASK TO PLAGIARISM CHECKING.

JAXON BELL
 100660344
 22477VIC
 Advanced Diploma of Building Design (Architectural)

holmesglen

AT4.2 APARTMENT BUILDING
 9-11 BEVIS STREET BENTLEIGH EAST VIC 3165 AUSTRALIA

DRAWING NAME:
 ELEVATIONS - SOUTH, WEST

FILE: WD_AT4.2_APARTMENT BUILDING.pln


DATE: 14/06/2026 **CHECKED:** TEACHER

DWG NO: A05-02 **REVISION:** A

SCALE: 1:100 **at** A1


LEGEND	
DP	DOWNPIPE
OF	OVERFLOW
WM	WATER METER CUPBOARD
RWP	RAIN WATER PUMP
FHB	FIRE HYDRANT BOOSTER

EXTERNAL FINISHES	
EF-01	CSR 20mm STONE PANELS - SANDSTONE FINISH
EF-02	CEMENT SHEET & MOULDINGS - WHITE RENDER FINISH
EF-04	CONCRETE FACADE TILES - GRAY FINISH (ROUGH)
EF-05	BALLUSTRADE GLAZING - CLEAR
EF-06	TIMBER - DARK OAK

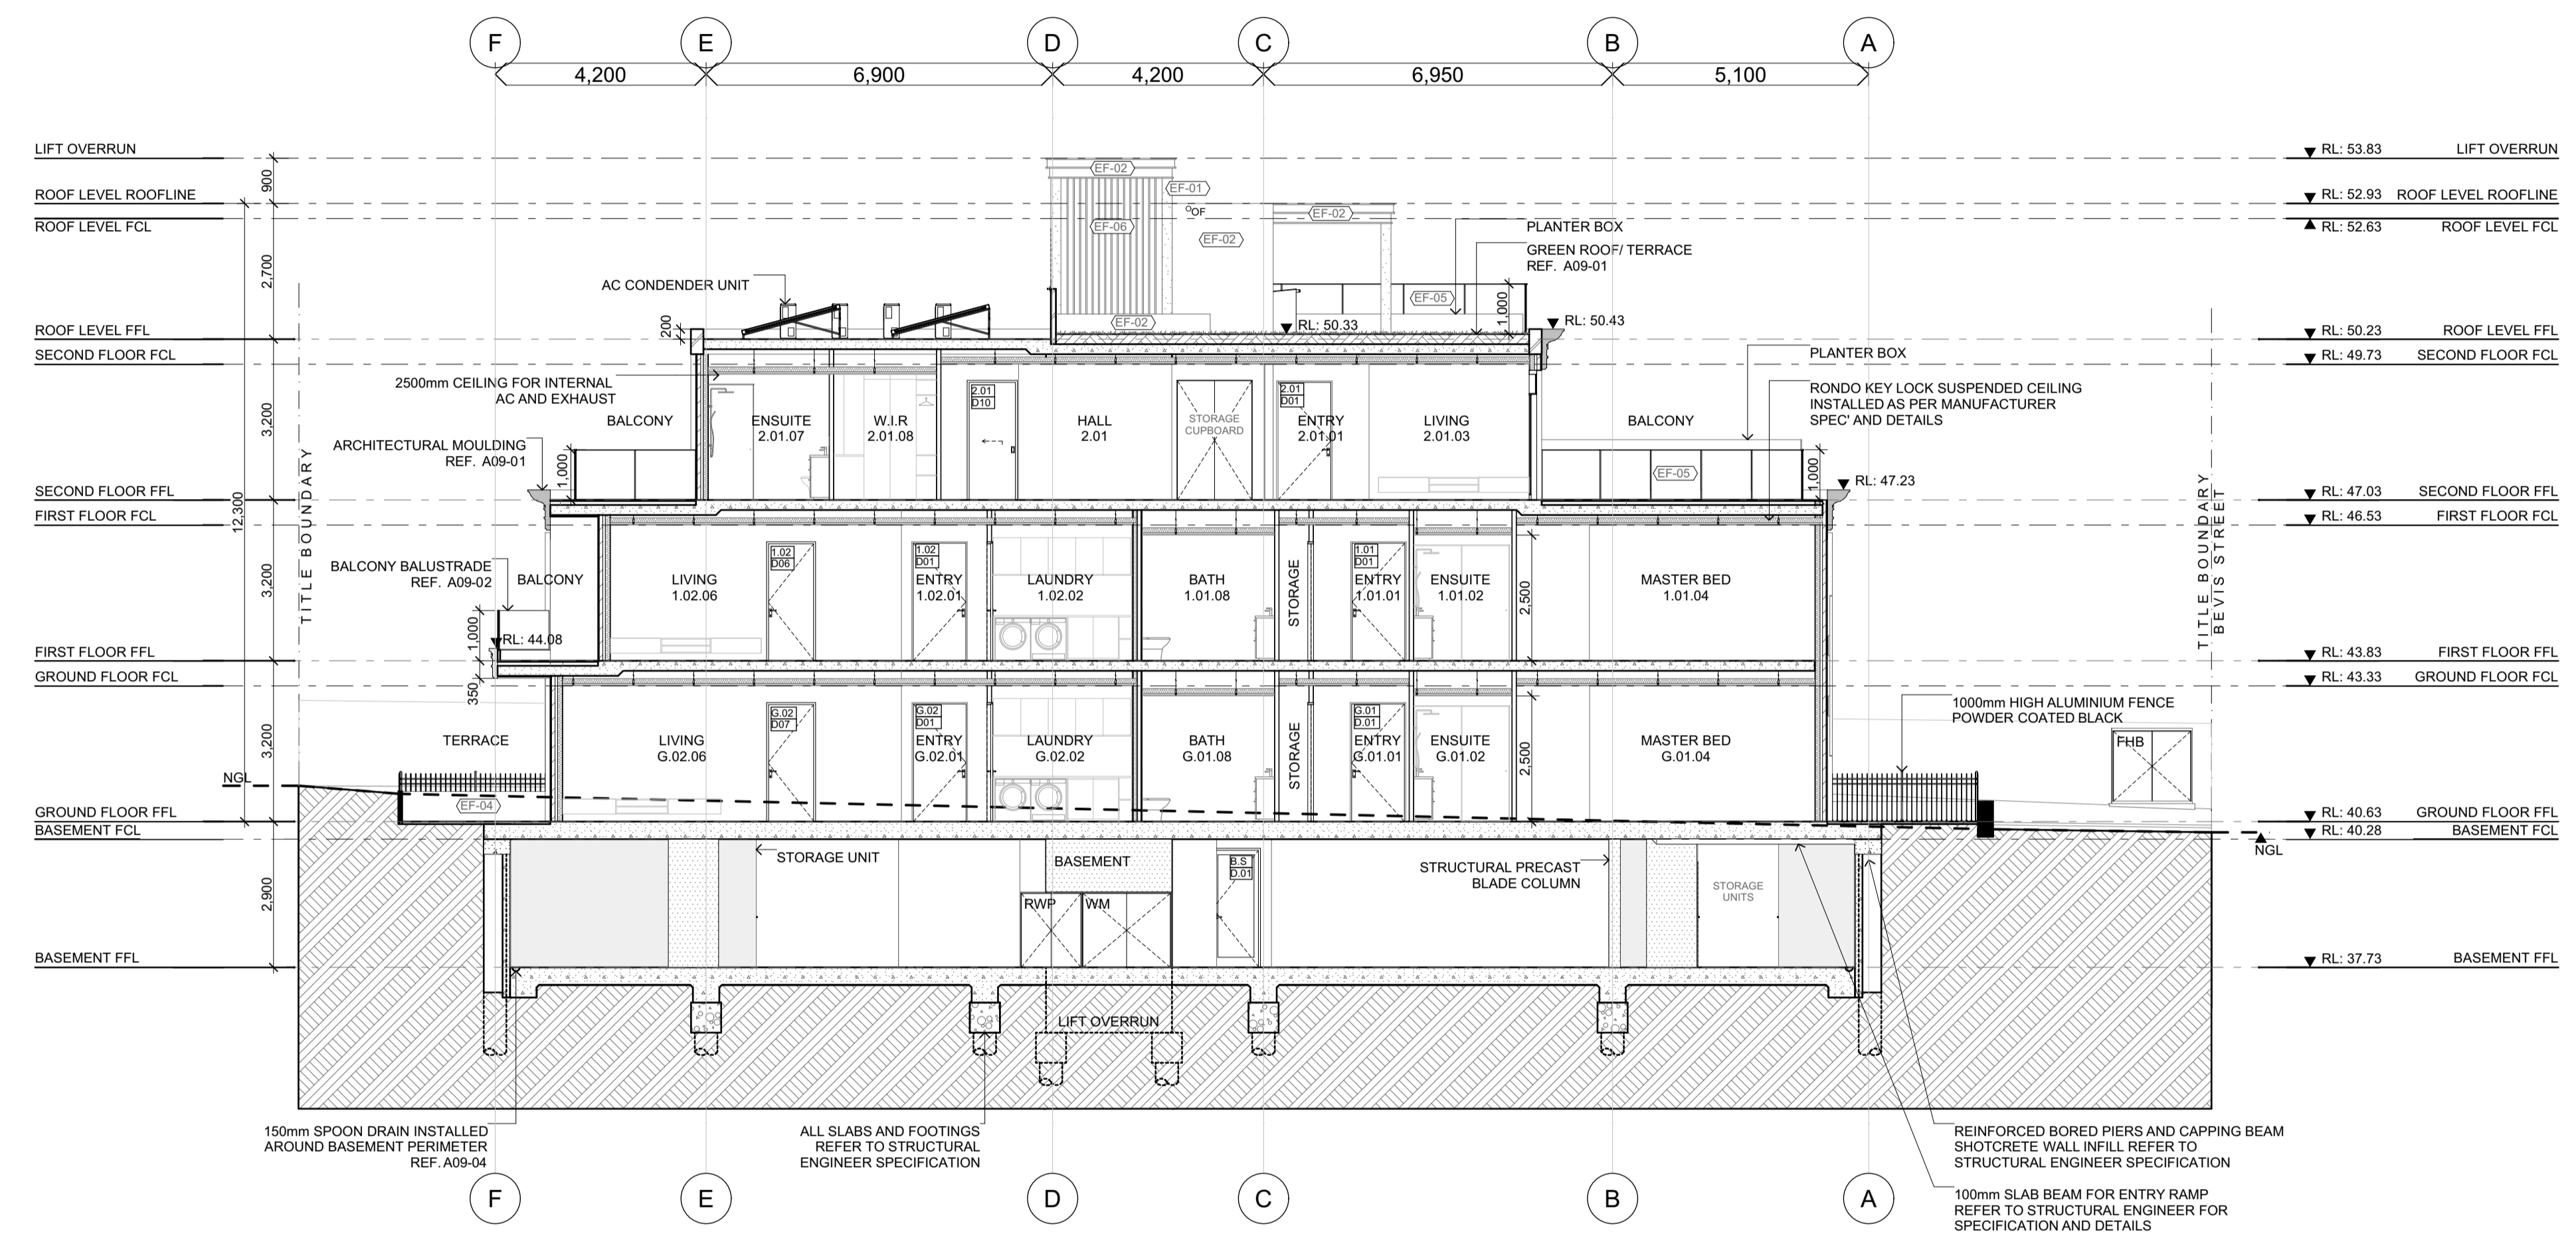

A-A
A02-01

SECTION A-A

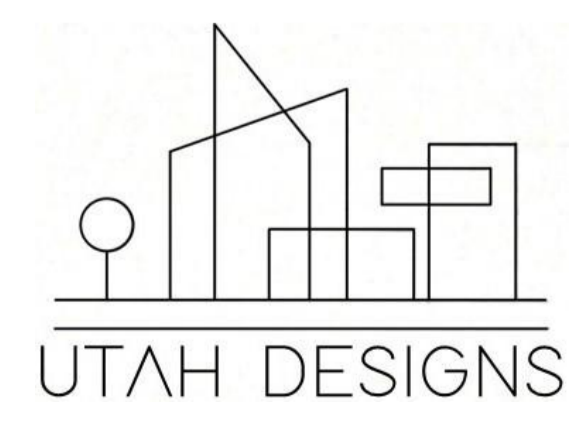

Rev	ChID	Description	Date
	P	PRELIMINARY SUBMISSION	22/05/26
A	P	PRELIM (ADJUSTMENTS MADE FROM FEEDBACK)	29/05/26
A	P	TR PRELIMINARY SUBMISSION	4/06/26
A	F	FINAL SUBMISSION	12/06/26

NOTES:
 THE BUILDER SHALL CHECK AND VERIFY ALL DIMENSIONS AND NOTIFY ALL ERRORS AND OMISSIONS TO THE DESIGNER.
 DO NOT SCALE DRAWINGS.
 USE FIGURED DIMENSIONS ONLY. DRAWINGS ARE NOT TO BE USED FOR CONSTRUCTION UNTIL ISSUED BY THE DESIGNER FOR CONSTRUCTION.

STUDENT DECLARES THAT THIS ASSESSMENT TASK IS HER/HIS OWN WORK UNLESS OTHERWISE ACKNOWLEDGED AND IS IN ACCORDANCE WITH THE INSTITUTE'S PLAGIARISM POLICY. STUDENT ACKNOWLEDGES THAT THE ASSESSOR OF THIS ASSESSMENT TASK MAY:
 1. REPRODUCE THIS ASSESSMENT TASK AND PROVIDE A COPY TO ANOTHER MEMBER OF THE INSTITUTE OR DISPLAY THIS ASSESSMENT WITHIN THE INSTITUTE FOR EDUCATIONAL PURPOSES. 2. SUBMIT THE ASSESSMENT TASK TO PLAGIARISM CHECKING.

JAXON BELL
 100660344
 22477VIC

Advanced Diploma of Building Design (Architectural)

AT4.2 APARTMENT BUILDING
 9-11 BEVIS STREET BENTLEIGH EAST
 VIC 3165 AUSTRALIA

DRAWING NAME:
 SECTION A-A: LONGITUDINAL

FILE: WD_AT4.2_APARTMENT BUILDING.pln

DATE: 14/06/2026 **CHECKED:** TEACHER

DWG NO: A06-01 **REVISION:** A


SCALE: 1:100 **at** A1

LEGEND

DP	DOWNPIPE
OF	OVERFLOW
WM	WATER METER CUPBOARD


EXTERNAL FINISHES

EF-01	CSR 20mm STONE PANELS - SANDSTONE FINISH
EF-02	CEMENT SHEET & MOULDINGS - WHITE RENDER FINISH
EF-04	CONCRETE FACADE TILES - GRAY FINISH (ROUGH)
EF-05	BALLUSTRADE GLAZING - CLEAR
EF-06	TIMBER - DARK OAK

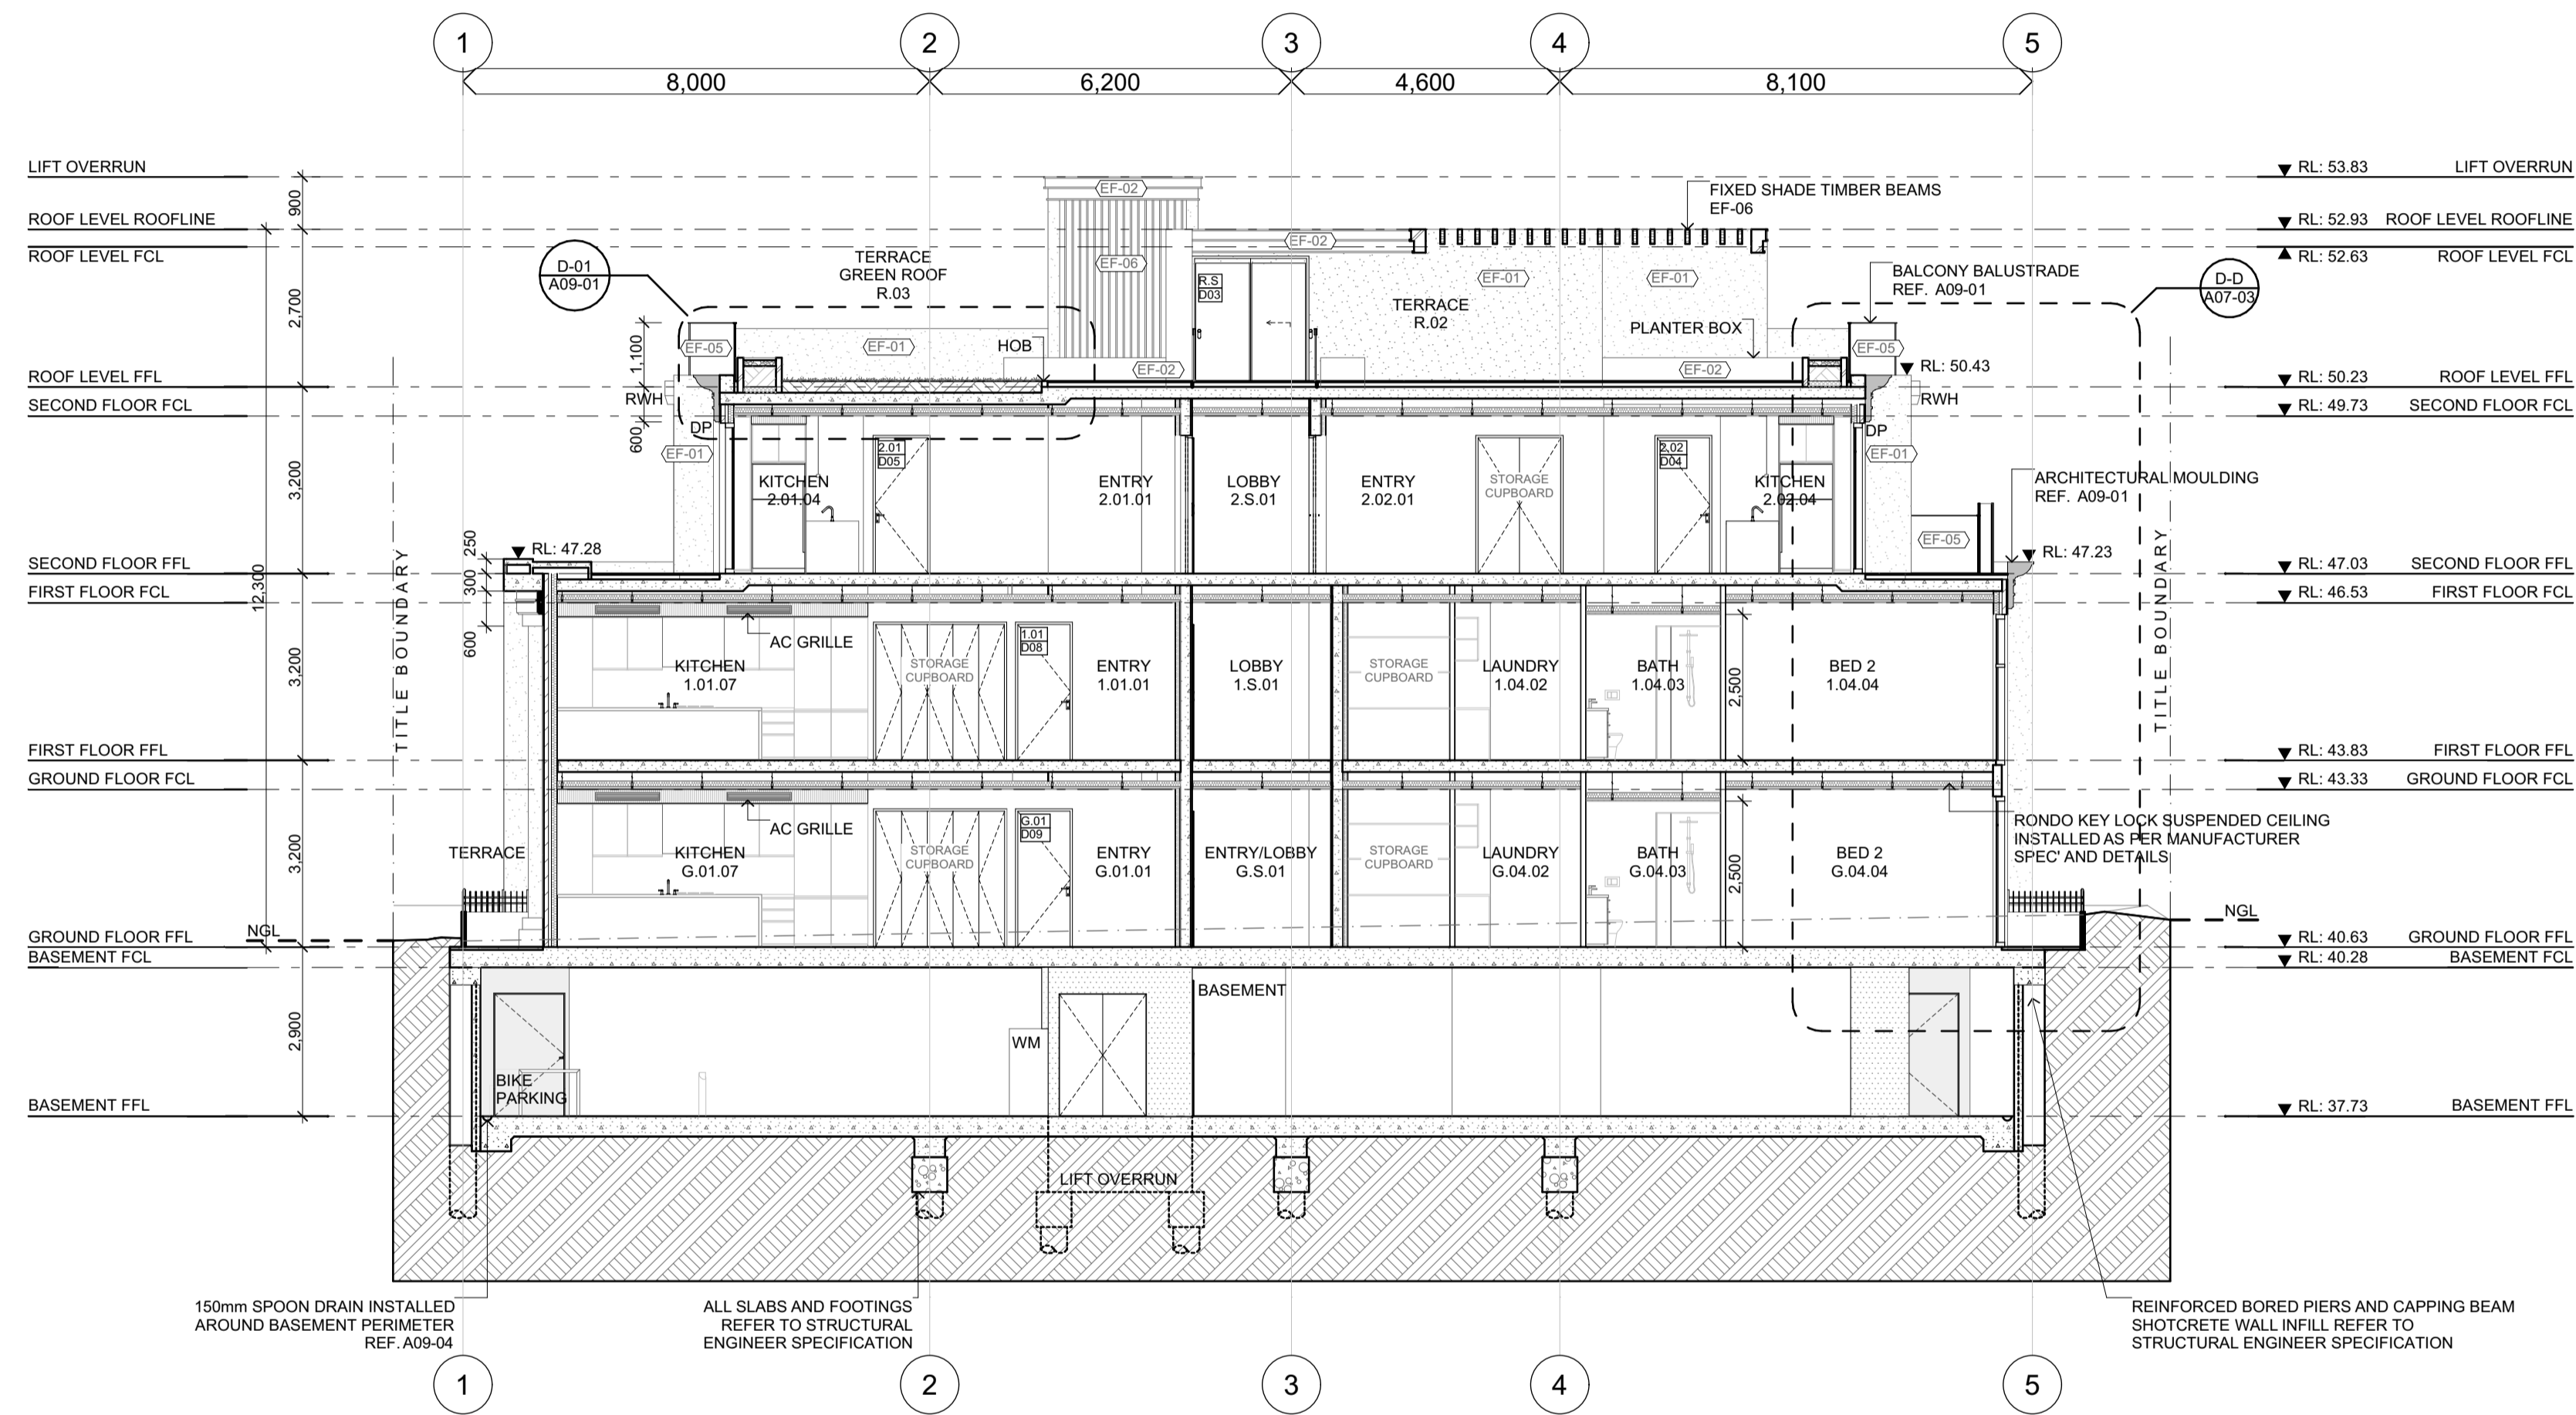

B-B
A02-01

SECTION B-B
1:100

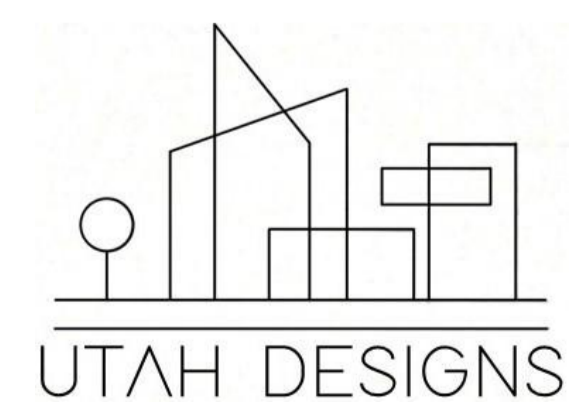

Rev	ChID	Description	Date
	P	PRELIMINARY SUBMISSION	22/05/26
A	P	PRELIM (ADJUSTMENTS MADE FROM FEEDBACK)	29/05/26
A	P	TR PRELIMINARY SUBMISSION	4/06/26
A	F	FINAL SUBMISSION	12/06/26

NOTES:
 THE BUILDER SHALL CHECK AND VERIFY ALL DIMENSIONS AND NOTIFY ALL ERRORS AND OMISSIONS TO THE DESIGNER.
 DO NOT SCALE DRAWINGS.
 USE FIGURED DIMENSIONS ONLY. DRAWINGS ARE NOT TO BE USED FOR CONSTRUCTION UNTIL ISSUED BY THE DESIGNER FOR CONSTRUCTION.

STUDENT DECLARES THAT THIS ASSESSMENT TASK IS HER/HIS OWN WORK UNLESS OTHERWISE ACKNOWLEDGED AND IS IN ACCORDANCE WITH THE INSTITUTE'S PLAGIARISM POLICY. STUDENT ACKNOWLEDGES THAT THE ASSESSOR OF THIS ASSESSMENT TASK MAY:
 1. REPRODUCE THIS ASSESSMENT TASK AND PROVIDE A COPY TO ANOTHER MEMBER OF THE INSTITUTE OR DISPLAY THIS ASSESSMENT WITHIN THE INSTITUTE FOR EDUCATIONAL PURPOSES. 2. SUBMIT THE ASSESSMENT TASK TO PLAGIARISM CHECKING.

JAXON BELL
 100660344
 22477VIC

holmesglen
 Advanced Diploma of Building Design (Architectural)

AT4.2 APARTMENT BUILDING
 9-11 BEVIS STREET BENTLEIGH EAST
 VIC 3165 AUSTRALIA


DRAWING NAME:
 SECTION B-B: LATERAL

FILE: WD_AT4.2_APARTMENT BUILDING.pln


DATE: 14/06/2026 CHECKED: TEACHER

DWG NO: **A06-02** REVISION: **A**

SCALE: 1:100 at A1

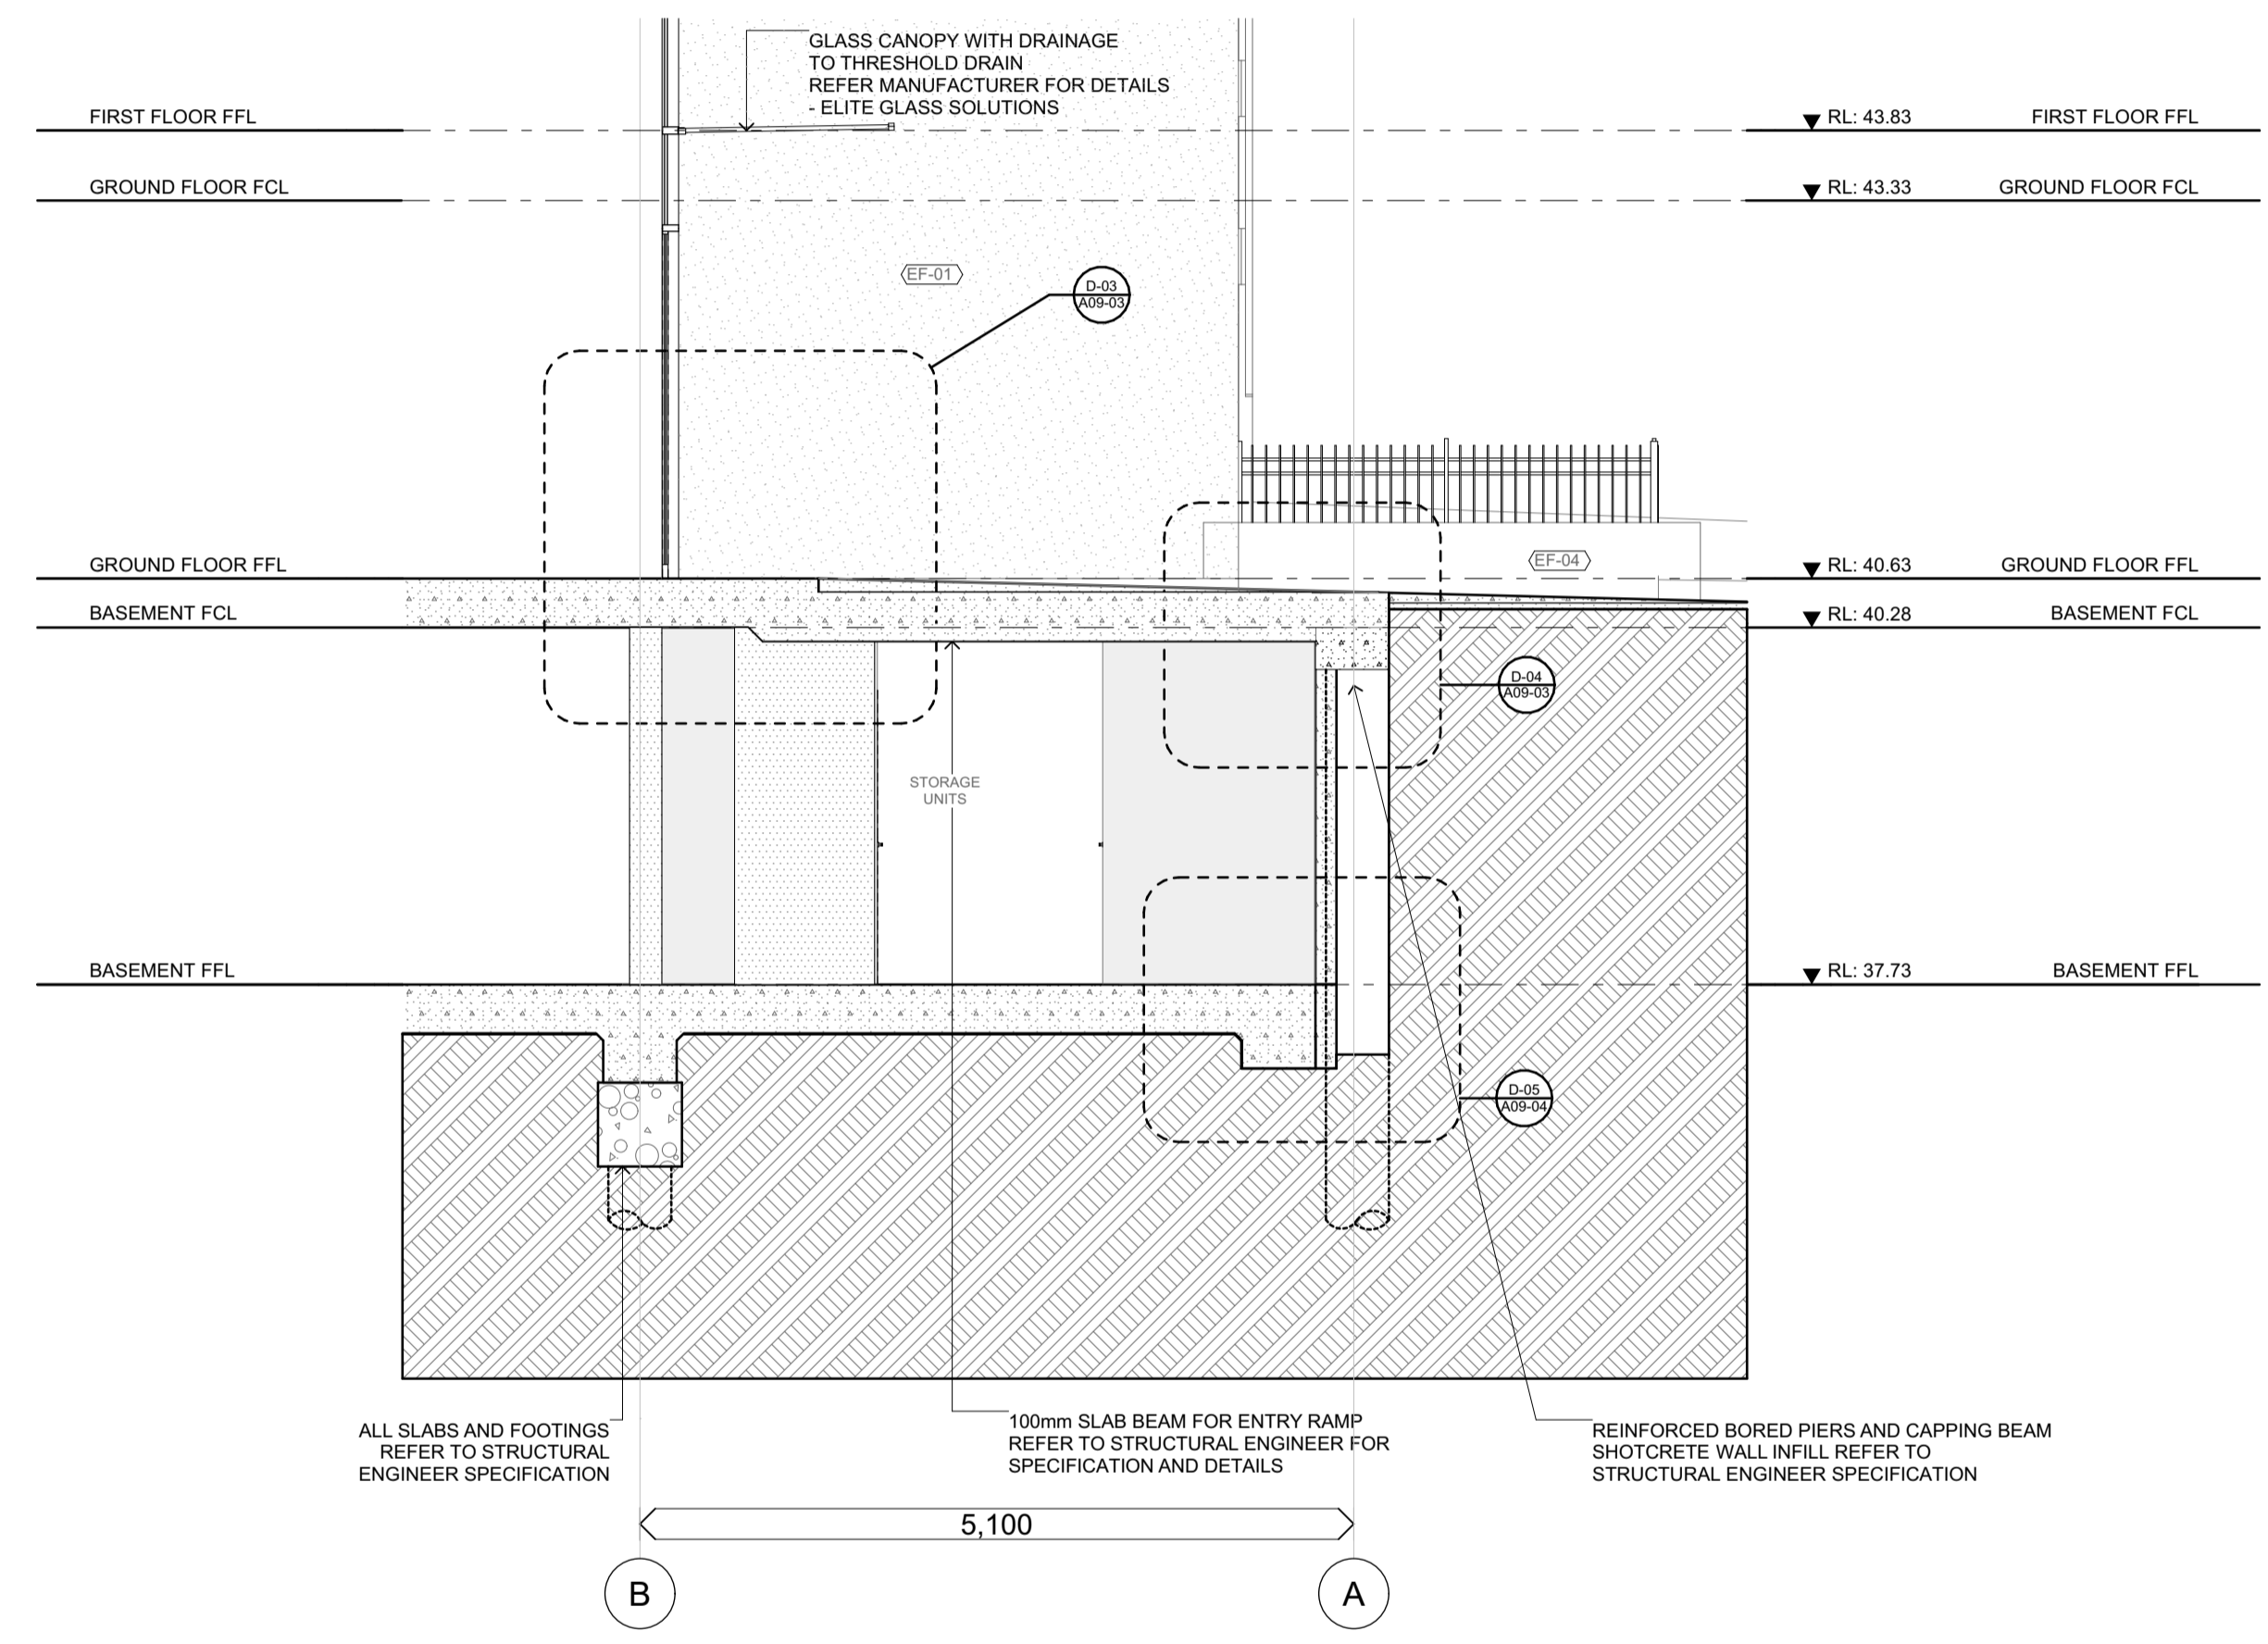

C-C SECTION C-C
A02-01 1:50

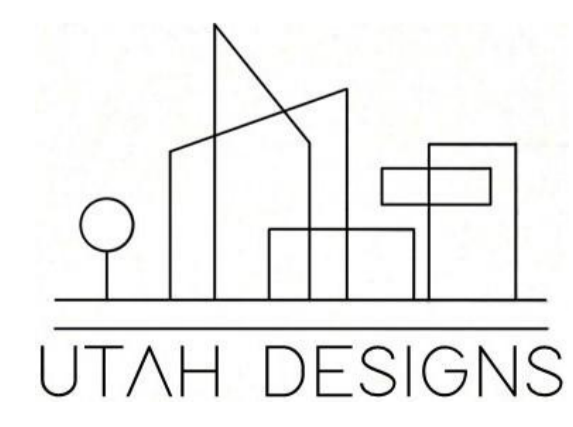

Rev	ChID	Description	Date
P		PRELIMINARY SUBMISSION	22/05/26
P		TR PRELIMINARY SUBMISSION	4/06/26
A	F	FINAL SUBMISSION	12/06/26

NOTES:
 THE BUILDER SHALL CHECK AND VERIFY ALL DIMENSIONS AND NOTIFY ALL ERRORS AND OMISSIONS TO THE DESIGNER.
 DO NOT SCALE DRAWINGS.
 USE FIGURED DIMENSIONS ONLY. DRAWINGS ARE NOT TO BE USED FOR CONSTRUCTION UNTIL ISSUED BY THE DESIGNER FOR CONSTRUCTION.
 STUDENT DECLARES THAT THIS ASSESSMENT TASK IS HER/HIS OWN WORK UNLESS OTHERWISE ACKNOWLEDGED AND IS IN ACCORDANCE WITH THE INSTITUTE'S PLAGIARISM POLICY. STUDENT ACKNOWLEDGES THAT THE ASSESSOR OF THIS ASSESSMENT TASK MAY:
 1. REPRODUCE THIS ASSESSMENT TASK AND PROVIDE A COPY TO ANOTHER MEMBER OF THE INSTITUTE OR DISPLAY THIS ASSESSMENT WITHIN THE INSTITUTE FOR EDUCATIONAL PURPOSES. 2. SUBMIT THE ASSESSMENT TASK TO PLAGIARISM CHECKING.

JAXON BELL
 100660344
 22477VIC
 Advanced Diploma of Building Design (Architectural)

AT4.2 APARTMENT BUILDING
 9-11 BEVIS STREET BENTLEIGH EAST
 VIC 3165 AUSTRALIA

DRAWING NAME:
 SECTION C-C: BASEMENT DETAILS

FILE: WD_AT4.2_APARTMENT BUILDING.pln

DATE: 14/06/2026 CHECKED: TEACHER

DWG NO: A06-03 REVISION: A

SCALE: 1:50 at A1

WT-00	WALL SYSTEM PRECAST CONCRETE WALL - EXPOSED , LOADBEARING	
	FIRE RATING 240/240/240	ACOUSTIC RATING N/A
	NCC REQUIRED FIRE RATIGN 90/90/90	NCC REQUIRED ACOUSTIC RATING N/A

WT-00b	WALL SYSTEM PRECAST CONCRETE WALL WITH CLADDING ONE SIDE , LOADBEARING	
	FIRE RATING 240/240/240	ACOUSTIC RATING N/A
	NCC REQUIRED FIRE RATIGN 90/90/90	NCC REQUIRED ACOUSTIC RATING N/A

WT-01	WALL SYSTEM EXTERNAL HEBEL POWERPANEL WALL WITH EXTERNAL CLADDING, LOADBEARING	
	FIRE RATING 120/120/120	ACOUSTIC RATING (R^w)50 (R^w+C^{tr})41
	NCC REQUIRED FIRE RATIGN 90/90/90	NCC REQUIRED ACOUSTIC RATING N/A

DISCONTINUOUS CONSTRUCTION/ IMPACT REQUIRED **N/A**

FOR WET AREAS:
SUBSTITUTE FOR GYROCK
AQUACHEK PLASTERBOARD

WT-02	WALL SYSTEM PRECAST CONCRETE WALL WITH INTERNAL STUD AND EXTERNAL CLADDING , LOADBEARING	
	FIRE RATING 240/240/240	ACOUSTIC RATING (R^w)56
	NCC REQUIRED FIRE RATIGN 90/90/90	NCC REQUIRED ACOUSTIC RATING R_w ≥50

DISCONTINUOUS CONSTRUCTION/ IMPACT REQUIRED **N/A**

FOR WET AREAS:
SUBSTITUTE FOR GYROCK
AQUACHEK PLASTERBOARD


WT-03	WALL SYSTEM PRECAST CONCRETE WALL WITH INTERNAL STUD, SOU TO LIFT SHAFT, LOADBEARING	
	FIRE RATING 240/240/240	ACOUSTIC RATING (R^w)56
	NCC REQUIRED FIRE RATIGN 90/90/90	NCC REQUIRED ACOUSTIC RATING R_w ≥50

DISCONTINUOUS CONSTRUCTION/ IMPACT REQUIRED **YES**

WT-04	WALL SYSTEM PRECAST CONCRETE WALL WITH INTERNAL FURRING CHANNEL, LOADBEARING	
	FIRE RATING 240/240/240	ACOUSTIC RATING (R^w)53
	NCC REQUIRED FIRE RATIGN 90/90/90	NCC REQUIRED ACOUSTIC RATING R_w ≥50

DISCONTINUOUS CONSTRUCTION/ IMPACT REQUIRED **N/A**

FOR WET AREAS:
SUBSTITUTE FOR GYROCK
AQUACHEK PLASTERBOARD

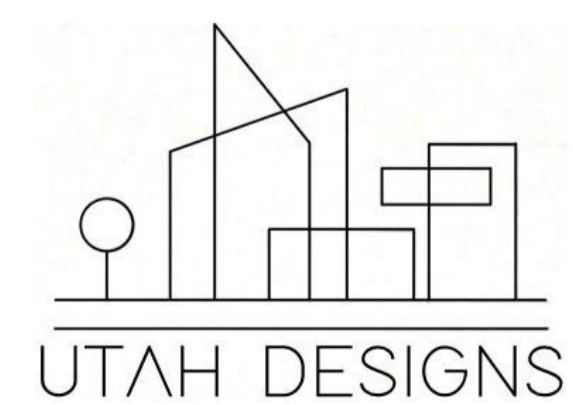

Rev	ChID	Description	Date
P		PRELIMINARY SUBMISSION	1/05/26
A		ADJUSTMENTS MADE FROM FEEDBACK	8/05/26
A		TR PRELIMINARY SUBMISSION	4/06/26
B		FINAL SUBMISSION	12/06/26

NOTES:
 THE BUILDER SHALL CHECK AND VERIFY ALL DIMENSIONS AND NOTIFY ALL ERRORS AND OMISSIONS TO THE DESIGNER.
 DO NOT SCALE DRAWINGS.
 USE FIGURED DIMENSIONS ONLY. DRAWINGS ARE NOT TO BE USED FOR CONSTRUCTION UNTIL ISSUED BY THE DESIGNER FOR CONSTRUCTION.
 STUDENT DECLARES THAT THIS ASSESSMENT TASK IS HER/HIS OWN WORK UNLESS OTHERWISE ACKNOWLEDGED AND IS IN ACCORDANCE WITH THE INSTITUTE'S PLAGIARISM POLICY. STUDENT ACKNOWLEDGES THAT THE ASSESSOR OF THIS ASSESSMENT TASK MAY:
 1. REPRODUCE THIS ASSESSMENT TASK AND PROVIDE A COPY TO ANOTHER MEMBER OF THE INSTITUTE OR DISPLAY THIS ASSESSMENT WITHIN THE INSTITUTE FOR EDUCATIONAL PURPOSES. 2. SUBMIT THE ASSESSMENT TASK TO PLAGIARISM CHECKING.

JAXON BELL
 100660344
 22477VIC
 Advanced Diploma of Building Design (Architectural)

AT4.2 APARTMENT BUILDING
 9-11 BEVIS STREET BENTLEIGH EAST
 VIC 3165 AUSTRALIA

DRAWING NAME:
WALL TYPES SCHEDULE: SHEET 1

FILE: WD_AT4.2_APARTMENT BUILDING.pln

DATE: 14/06/2026 CHECKED: TEACHER

DWG NO: **A07-01** REVISION: **B**

SCALE: 1:10 at A1

WT-05 CSR 3242(e)	WALL SYSTEM INTERNAL SOU TO NON-HABITABLE DOUBLE STUD WALL, LOADBEARING	
	FIRE RATING 90/90/90	ACOUSTIC RATING (R^w+C^{tr})56
	NCC REQUIRED FIRE RATIGN 90/90/90	NCC REQUIRED ACOUSTIC RATING R_w+C_{tr} ≥ 50
		DISCONTINUOUS CONSTRUCTION/ IMPACT REQUIRED YES

WT-06 CSR 10138(a)	WALL SYSTEM INTERNAL SOU SINGLE STUD WALL, NON-LOADBEARING	
	FIRE RATING -/-/-	ACOUSTIC RATING (R^w+C^{tr})27
	NCC REQUIRED FIRE RATIGN -/-/-	NCC REQUIRED ACOUSTIC RATING N/A
		DISCONTINUOUS CONSTRUCTION/ IMPACT REQUIRED N/A

FOR WET AREAS:
SUBSTITUTE FOR GYPROCK
AQUACHEK PLASTERBOARD

WT-06b CSR 10138(c)	WALL SYSTEM INTERNAL SOU SINGLE STUD WALL, INSULATED, NON-LOADBEARING	
	FIRE RATING -/-/-	ACOUSTIC RATING (R^w+C^{tr})27
	NCC REQUIRED FIRE RATIGN -/-/-	NCC REQUIRED ACOUSTIC RATING N/A
		DISCONTINUOUS CONSTRUCTION/ IMPACT REQUIRED N/A

FOR WET AREAS:
SUBSTITUTE FOR GYPROCK
AQUACHEK PLASTERBOARD


FOR SERVICES SIDE OF
WALL, NO PLASTERBOARD
WALL LINING IS TO BE USED

WT-07 CSR 4293(b)	WALL SYSTEM INTERNAL PRECAST WALL, HABITABLE TO HAITABLE, LOADBEARING	
	FIRE RATING 240/240/240	ACOUSTIC RATING (R^w+C^{tr})50
	NCC REQUIRED FIRE RATIGN 90/90/90	NCC REQUIRED ACOUSTIC RATING R_w+C_{tr} ≥ 50
		DISCONTINUOUS CONSTRUCTION/ IMPACT REQUIRED N/A

WT-08 CSR 3023(f)	WALL SYSTEM INTERNAL SOU SINGLE STUD WALL, SOU TO SERVICES, NON-LOADBEARING	
	FIRE RATING -/60/60	ACOUSTIC RATING (R^w+C^{tr})41
	NCC REQUIRED FIRE RATIGN -/60/60	NCC REQUIRED ACOUSTIC RATING (R^w+C^{tr})40
		DISCONTINUOUS CONSTRUCTION/ IMPACT REQUIRED N/A

FOR SERVICES SIDE OF
WALL, NO PLASTERBOARD
WALL LINING IS TO BE USED

FOR WET AREAS:
SUBSTITUTE FOR GYPROCK
AQUACHEK PLASTERBOARD

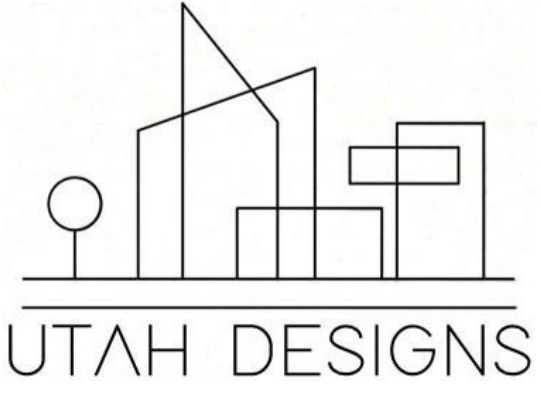

Rev	ChID	Description	Date
	P	PRELIMINARY SUBMISSION	1/05/26
A	P	ADJUSTMENTS MADE FROM FEEDBACK	8/05/26
A	P	TR PRELIMINARY SUBMISSION	4/06/26
B	F	FINAL SUBMISSION	12/06/26

NOTES:
THE BUILDER SHALL CHECK AND VERIFY ALL DIMENSIONS AND NOTIFY ALL ERRORS AND OMISSIONS TO THE DESIGNER.
DO NOT SCALE DRAWINGS.
USE FIGURED DIMENSIONS ONLY. DRAWINGS ARE NOT TO BE USED FOR CONSTRUCTION UNTIL ISSUED BY THE DESIGNER FOR CONSTRUCTION.

STUDENT DECLARES THAT THIS ASSESSMENT TASK IS HER/HIS OWN WORK UNLESS OTHERWISE ACKNOWLEDGED AND IS IN ACCORDANCE WITH THE INSTITUTE'S PLAGIARISM POLICY. STUDENT ACKNOWLEDGES THAT THE ASSESSOR OF THIS ASSESSMENT TASK MAY:
1. REPRODUCE THIS ASSESSMENT TASK AND PROVIDE A COPY TO ANOTHER MEMBER OF THE INSTITUTE OR DISPLAY THIS ASSESSMENT WITHIN THE INSTITUTE FOR EDUCATIONAL PURPOSES. 2. SUBMIT THE ASSESSMENT TASK TO PLAGIARISM CHECKING.

JAXON BELL
100660344
22477VIC
Advanced Diploma of Building Design (Architectural)

AT4.2 APARTMENT BUILDING
9-11 BEVIS STREET BENTLEIGH EAST
VIC 3165 AUSTRALIA


DRAWING NAME:
WALL TYPES SCHEDUEL: SHEET 2

FILE: WD_AT4.2_APARTMENT BUILDING.pln


DATE: 14/06/2026 CHECKED: TEACHER

DWG NO: **A07-02** REVISION: **B**

SCALE: 1:10 at A1

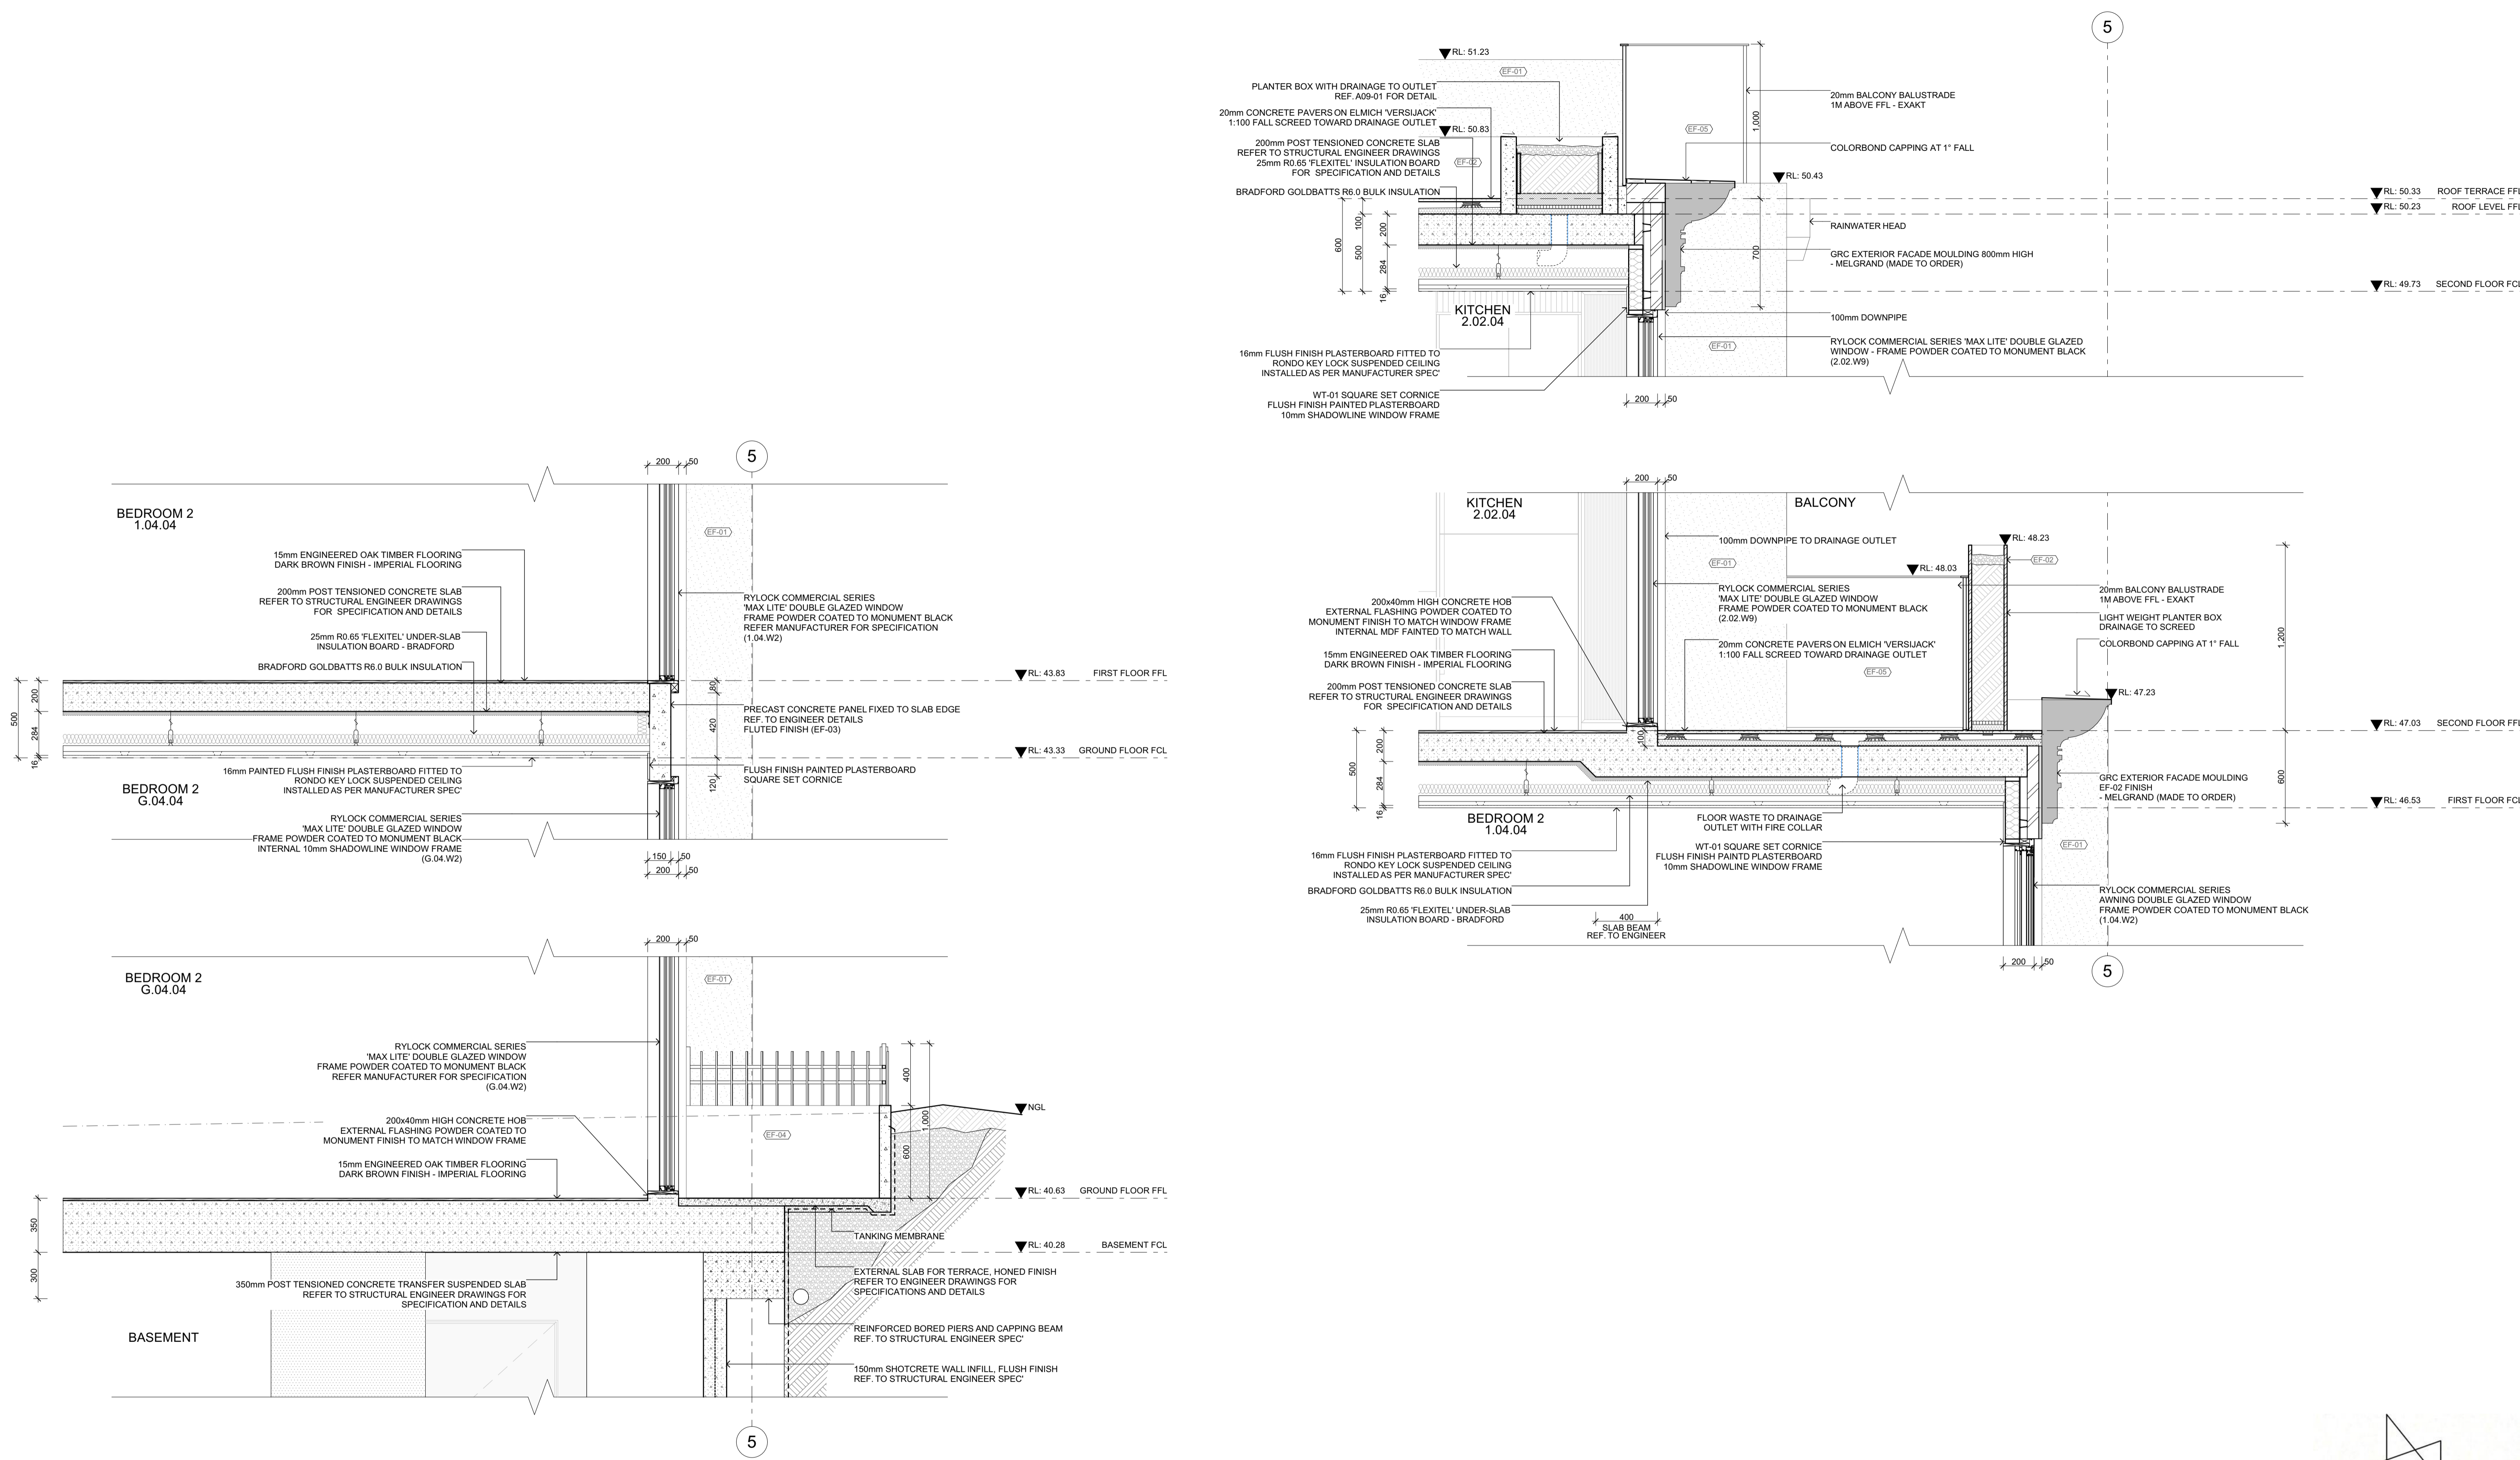

D-D
A06-02
DETAIL WALL SECTION
1:20

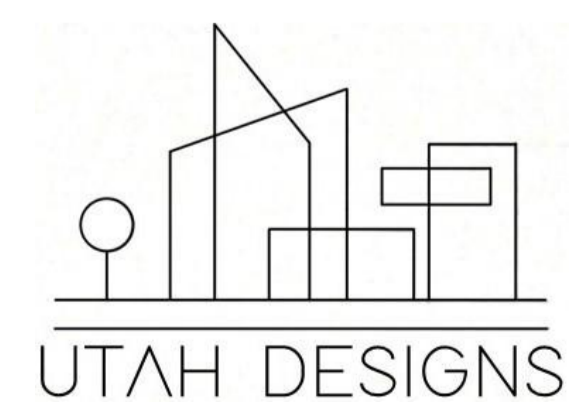

Rev	ChID	Description	Date
P		PRELIMINARY SUBMISSION	1/06/26
P		TR PRELIMINARY SUBMISSION	4/06/26
A	F	FINAL SUBMISSION	12/06/26

NOTES:
 THE BUILDER SHALL CHECK AND VERIFY ALL DIMENSIONS AND NOTIFY ALL ERRORS AND OMISSIONS TO THE DESIGNER.
 DO NOT SCALE DRAWINGS.
 USE FIGURED DIMENSIONS ONLY. DRAWINGS ARE NOT TO BE USED FOR CONSTRUCTION UNTIL ISSUED BY THE DESIGNER FOR CONSTRUCTION.
 STUDENT DECLARES THAT THIS ASSESSMENT TASK IS HER/HIS OWN WORK UNLESS OTHERWISE ACKNOWLEDGED AND IS IN ACCORDANCE WITH THE INSTITUTE'S PLAGIARISM POLICY. STUDENT ACKNOWLEDGES THAT THE ASSESSOR OF THIS ASSESSMENT TASK MAY:
 1. REPRODUCE THIS ASSESSMENT TASK AND PROVIDE A COPY TO ANOTHER MEMBER OF THE INSTITUTE OR DISPLAY THIS ASSESSMENT WITHIN THE INSTITUTE FOR EDUCATIONAL PURPOSES. 2. SUBMIT THE ASSESSMENT TASK TO PLAGIARISM CHECKING.

JAXON BELL
 100660344
 22477VIC
 Advanced Diploma of Building Design (Architectural)

AT4.2 APARTMENT BUILDING
 9-11 BEVIS STREET BENTLEIGH EAST
 VIC 3165 AUSTRALIA


DRAWING NAME:
 DETAIL WALL SECTIONS

FILE: WD_AT4.2_APARTMENT BUILDING.pln


DATE: 14/06/2026 **CHECKED:** TEACHER

DWG NO: A07-03 **REVISION:** A


SCALE: 1:20 **at** A1

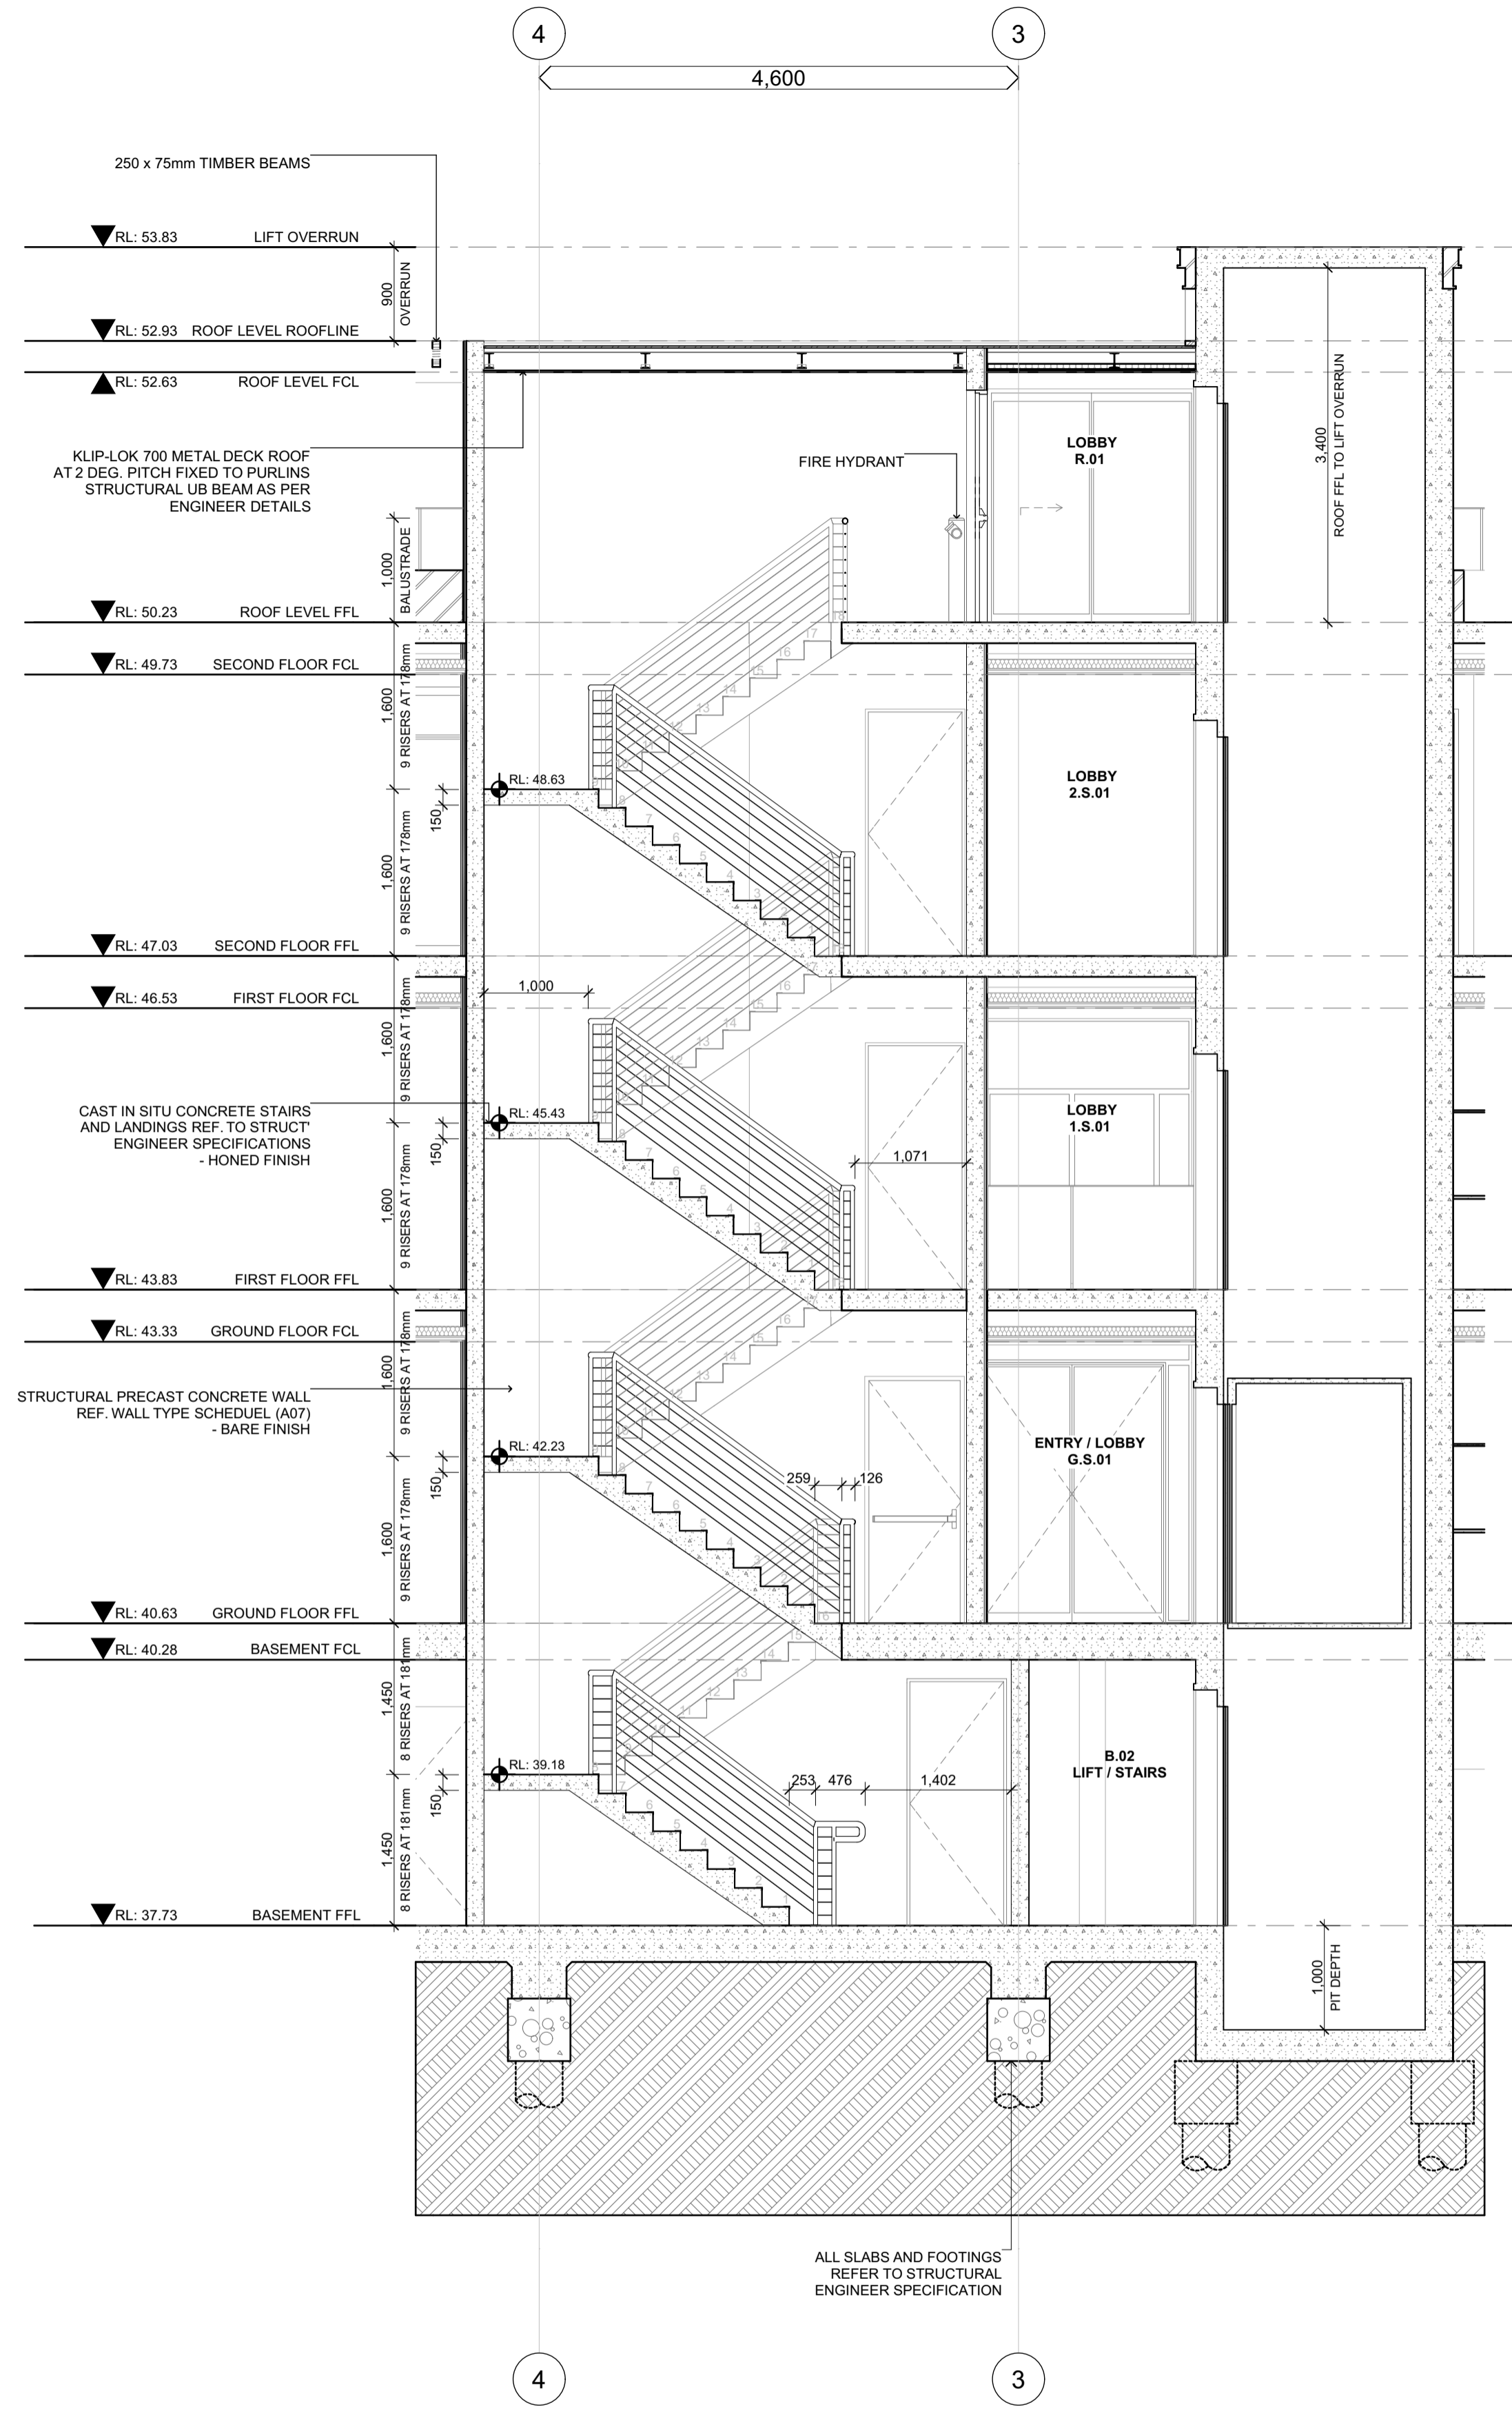


V-C A02-01 VERTICAL CIRCULATION SECTION 1:50

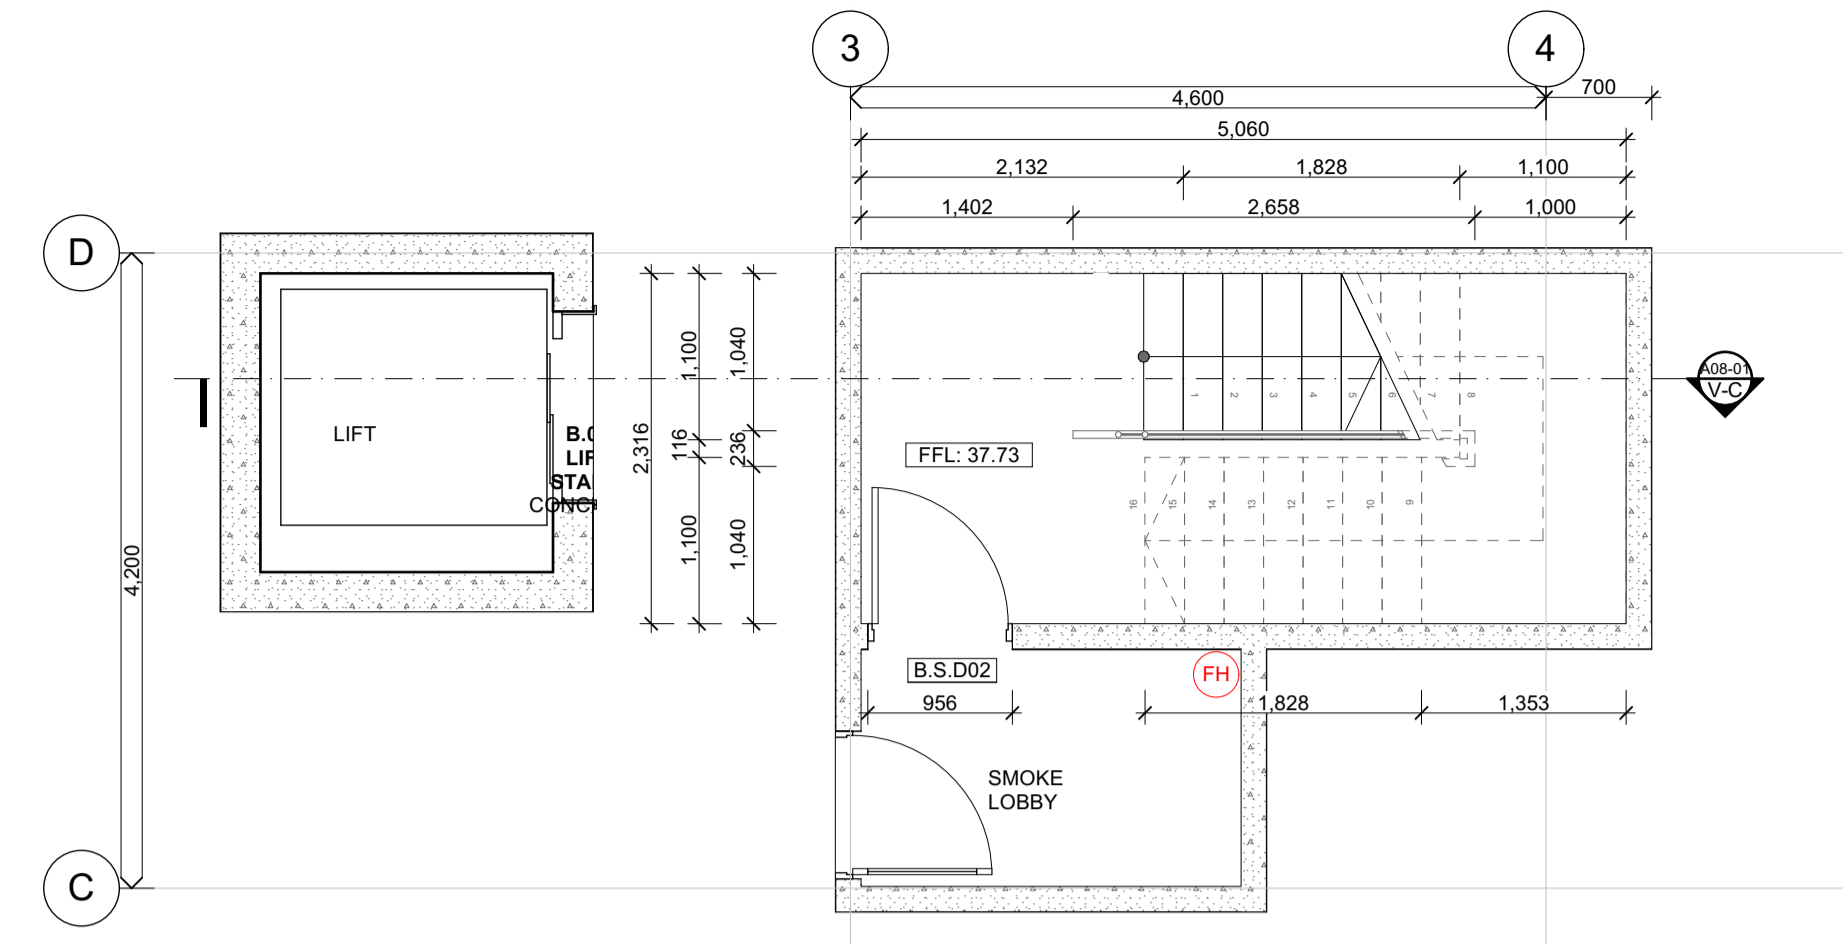


BASEMENT - LIFT, STAIRS 1:50

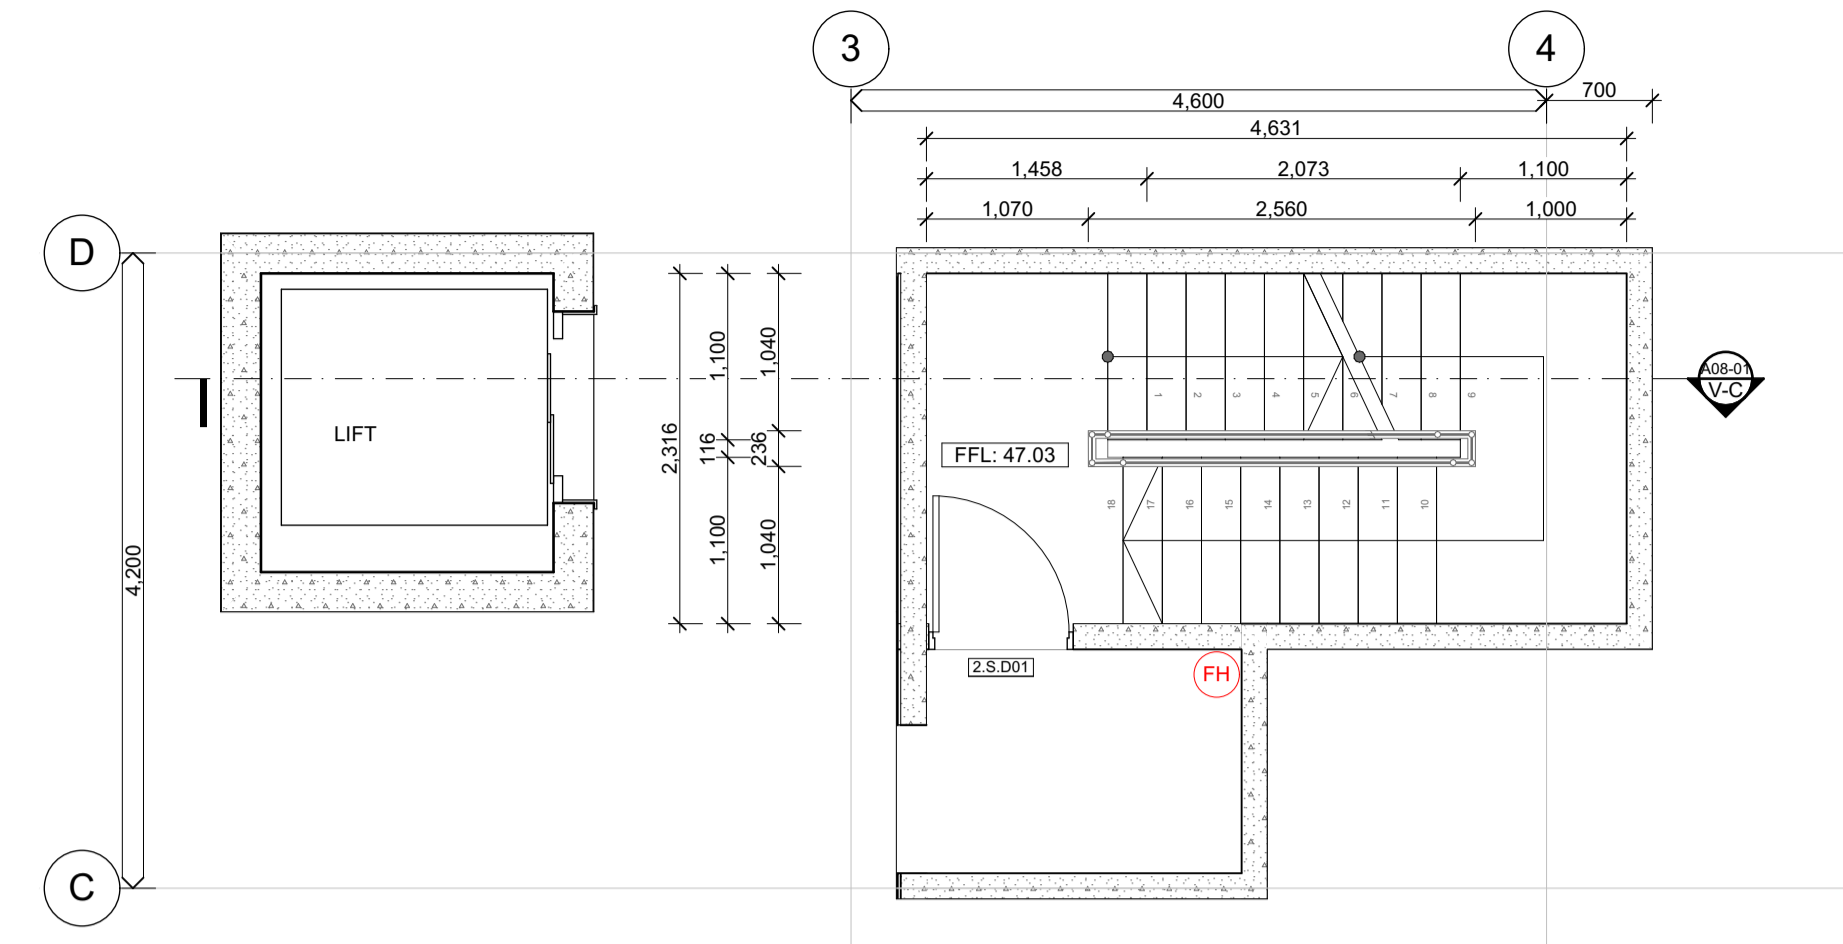


SECOND FLOOR - LIFT, STAIRS 1:50

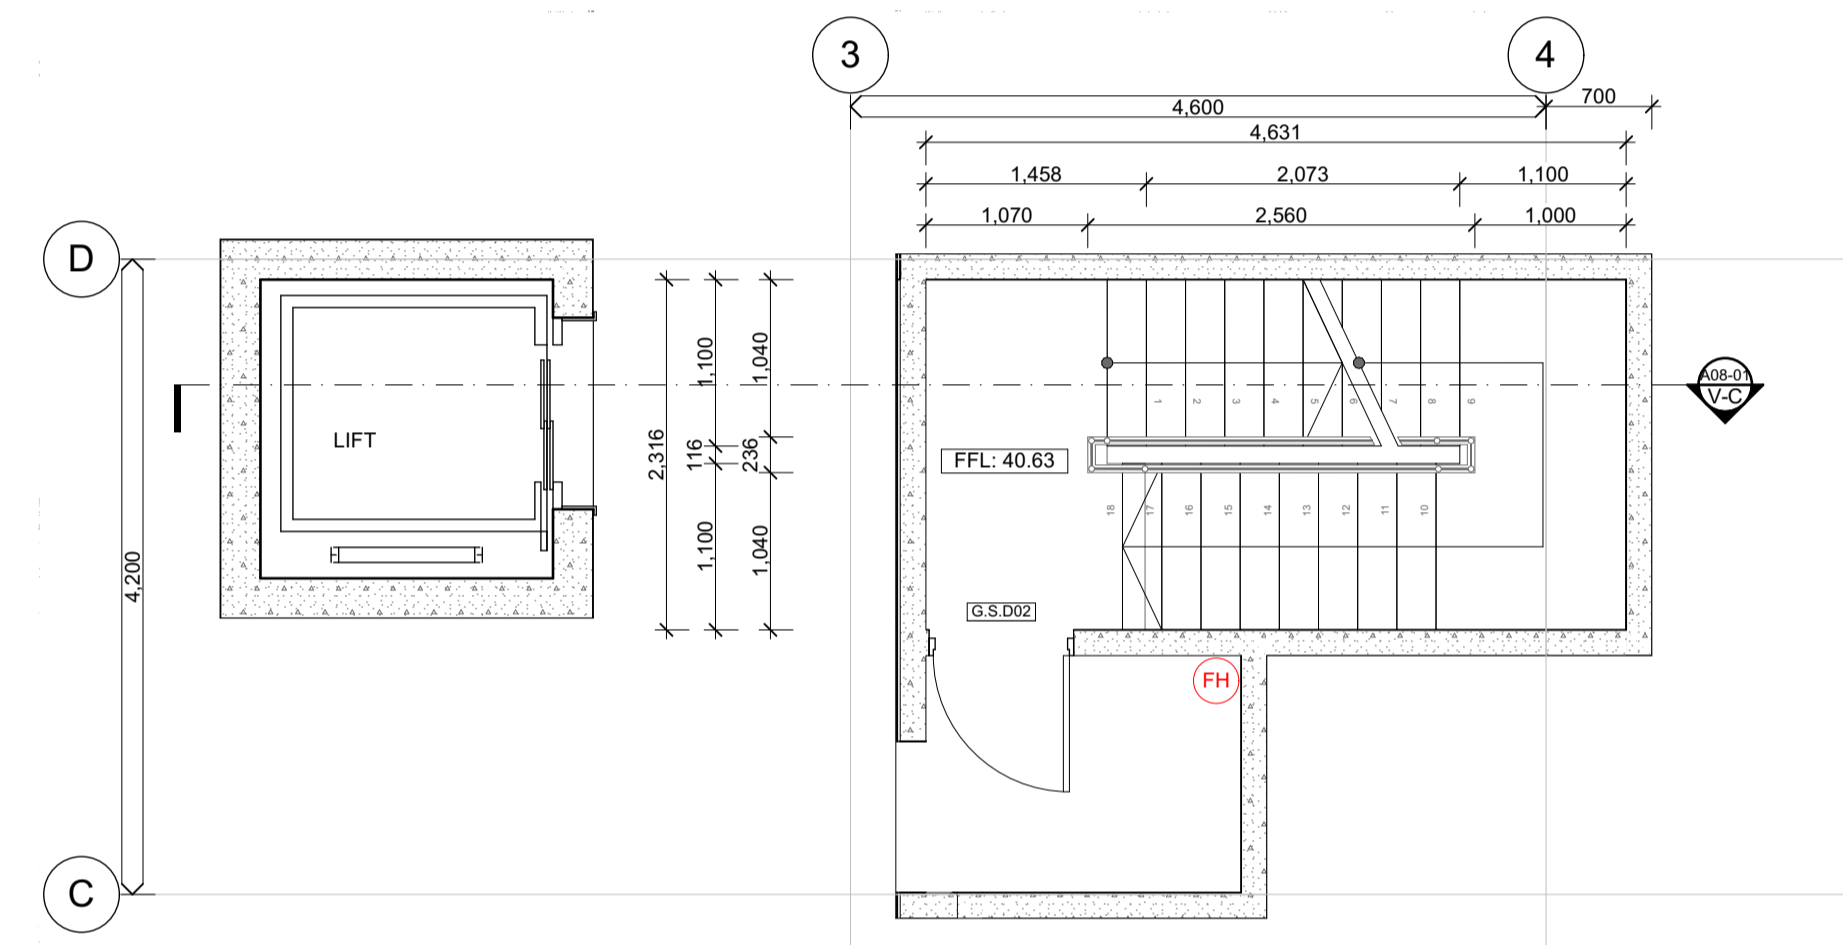


GROUND FLOOR - LIFT, STAIRS 1:50

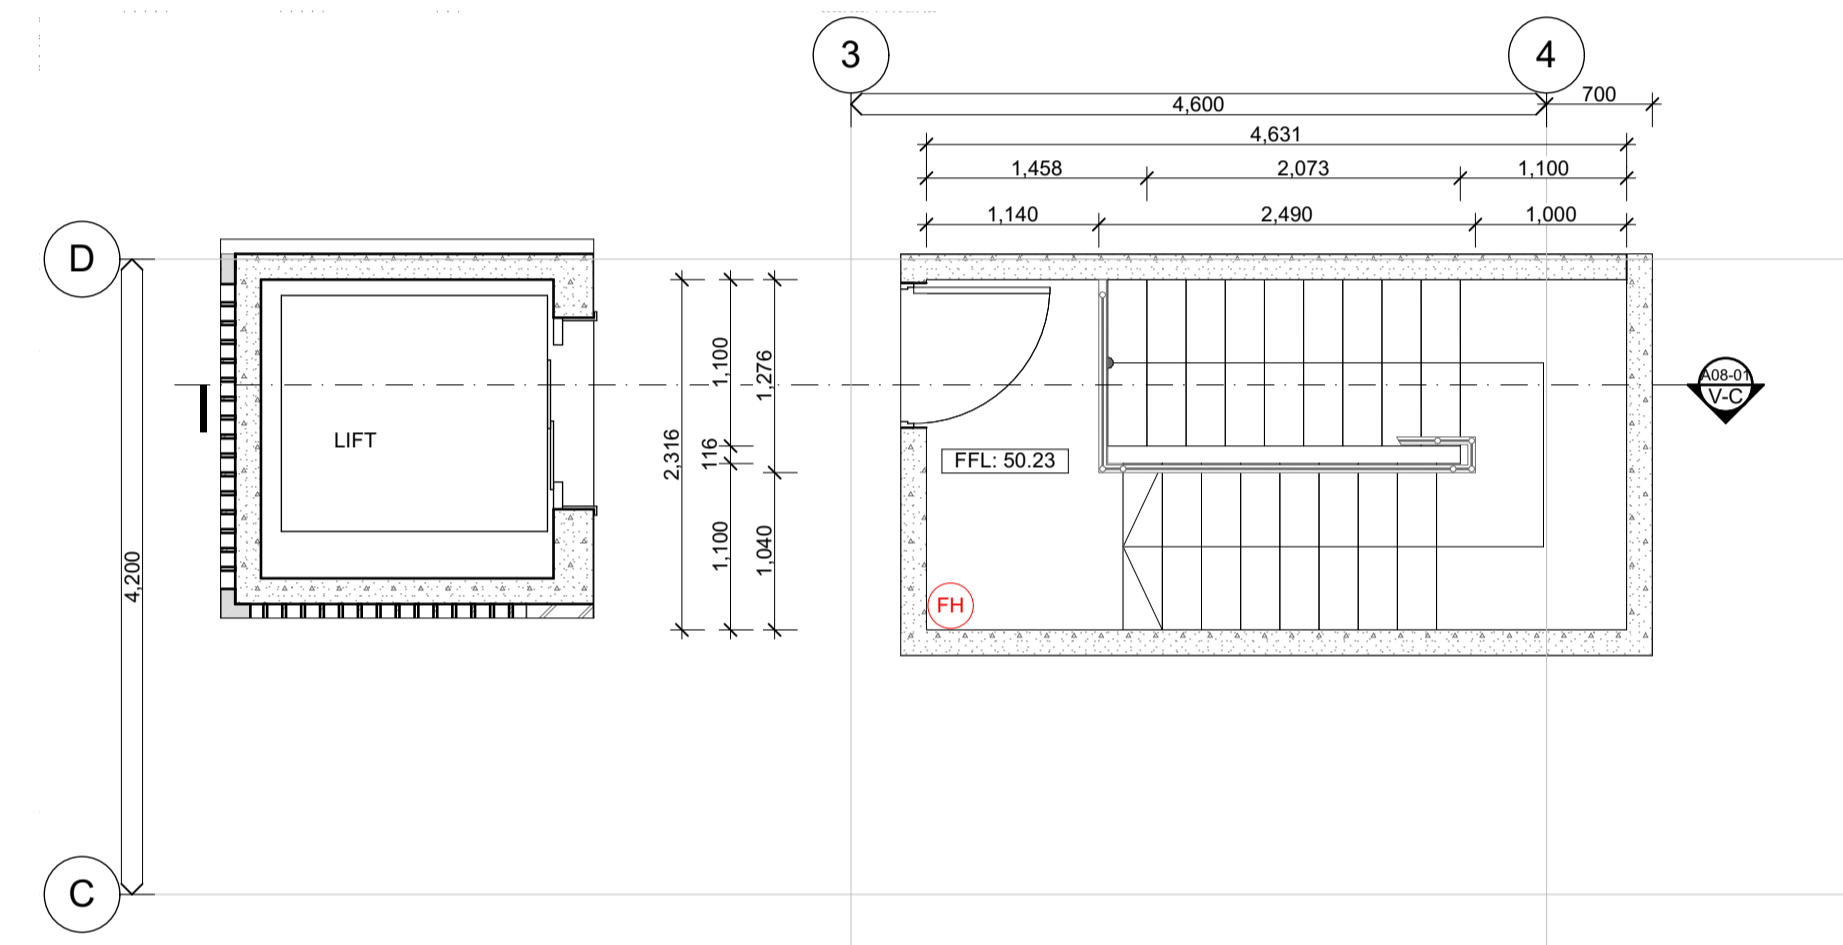

ROOF LEVEL - LIFT, STAIRS 1:50

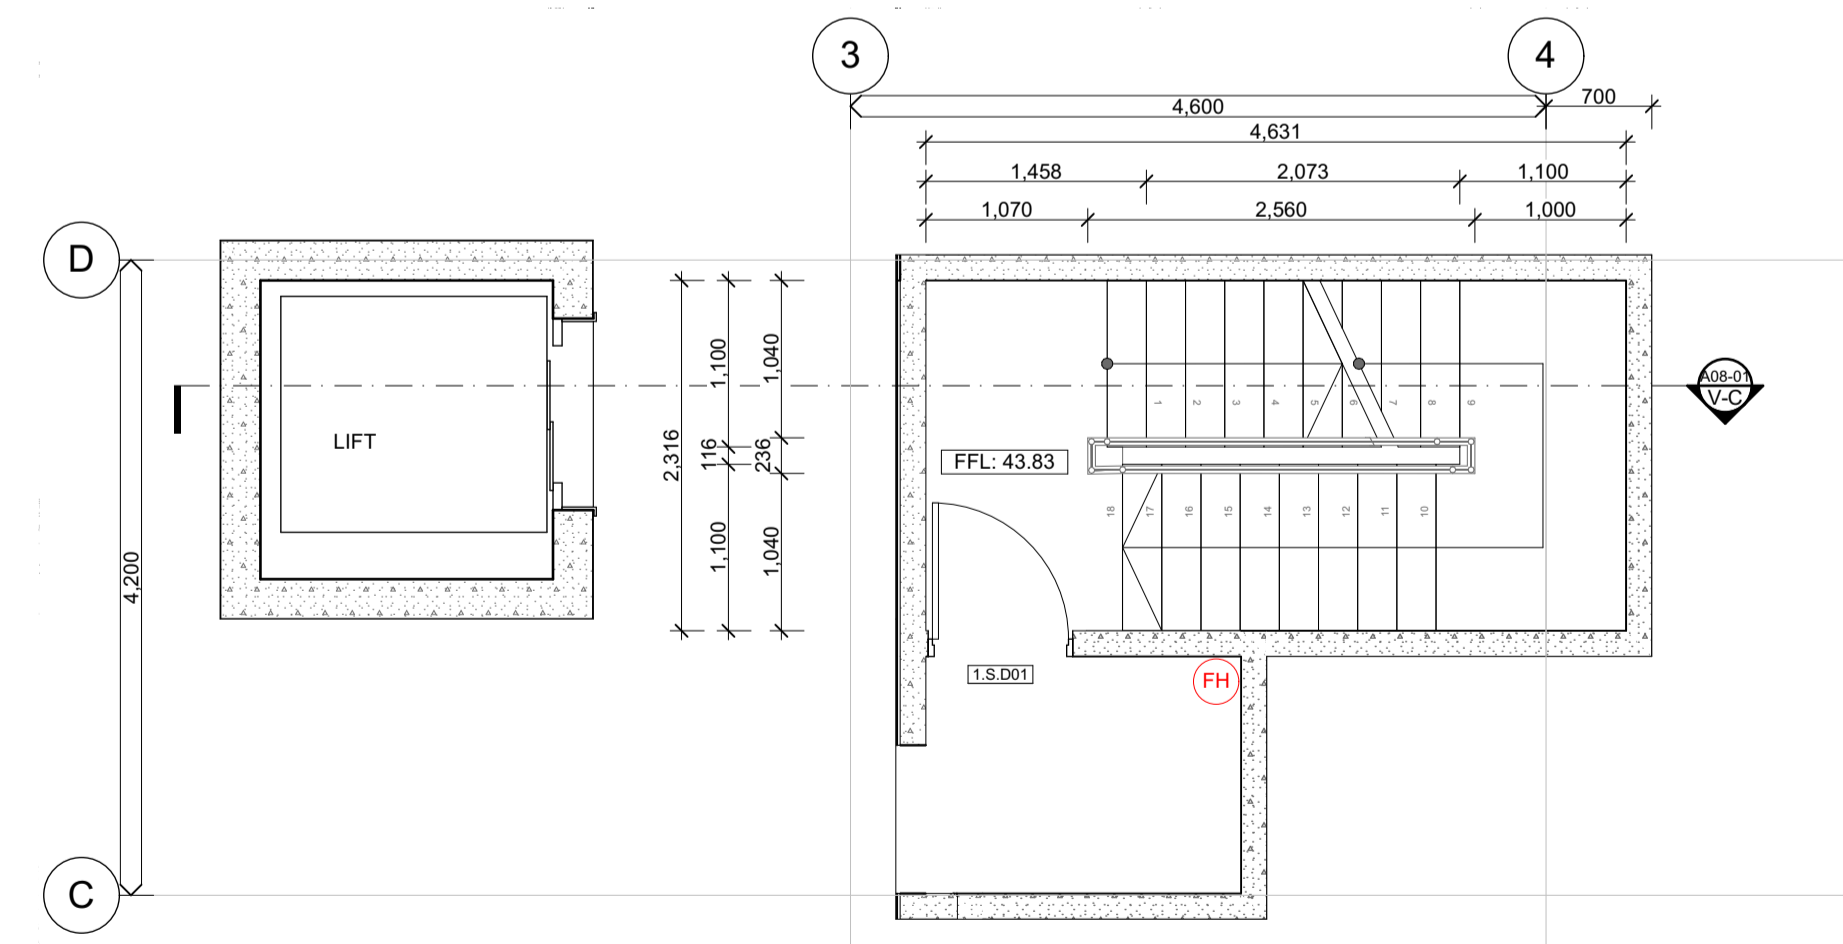

FIRST FLOOR - LIFT, STAIRS 1:50

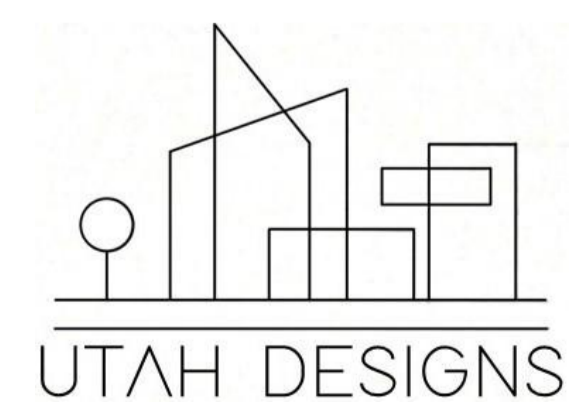

Rev	ChID	Description	Date
P		PRELIMINARY SUBMISSION	29/05/26
P		TR PRELIMINARY SUBMISSION	4/06/26
A	F	FINAL SUBMISSION	12/06/26

NOTES:
 THE BUILDER SHALL CHECK AND VERIFY ALL DIMENSIONS AND NOTIFY ALL ERRORS AND OMISSIONS TO THE DESIGNER.
 DO NOT SCALE DRAWINGS.
 USE FIGURED DIMENSIONS ONLY. DRAWINGS ARE NOT TO BE USED FOR CONSTRUCTION UNTIL ISSUED BY THE DESIGNER FOR CONSTRUCTION.
 STUDENT DECLARES THAT THIS ASSESSMENT TASK IS HER/HIS OWN WORK UNLESS OTHERWISE ACKNOWLEDGED AND IS IN ACCORDANCE WITH THE INSTITUTE'S PLAGIARISM POLICY. STUDENT ACKNOWLEDGES THAT THE ASSESSOR OF THIS ASSESSMENT TASK MAY:
 1. REPRODUCE THIS ASSESSMENT TASK AND PROVIDE A COPY TO ANOTHER MEMBER OF THE INSTITUTE OR DISPLAY THIS ASSESSMENT WITHIN THE INSTITUTE FOR EDUCATIONAL PURPOSES. 2. SUBMIT THE ASSESSMENT TASK TO PLAGIARISM CHECKING.

JAXON BELL
 100660344
 22477VIC
 Advanced Diploma of Building Design (Architectural)

AT4.2 APARTMENT BUILDING
 9-11 BEVIS STREET BENTLEIGH EAST
 VIC 3165 AUSTRALIA


DRAWING NAME:
 VERTICAL CIRCULATION - LIFT, STAIRS

FILE: WD_AT4.2_APARTMENT BUILDING.pln


DATE: 14/06/2026 **CHECKED:** TEACHER

DWG NO: A08-01 **REVISION:** A

SCALE: 1:50 **at** A1

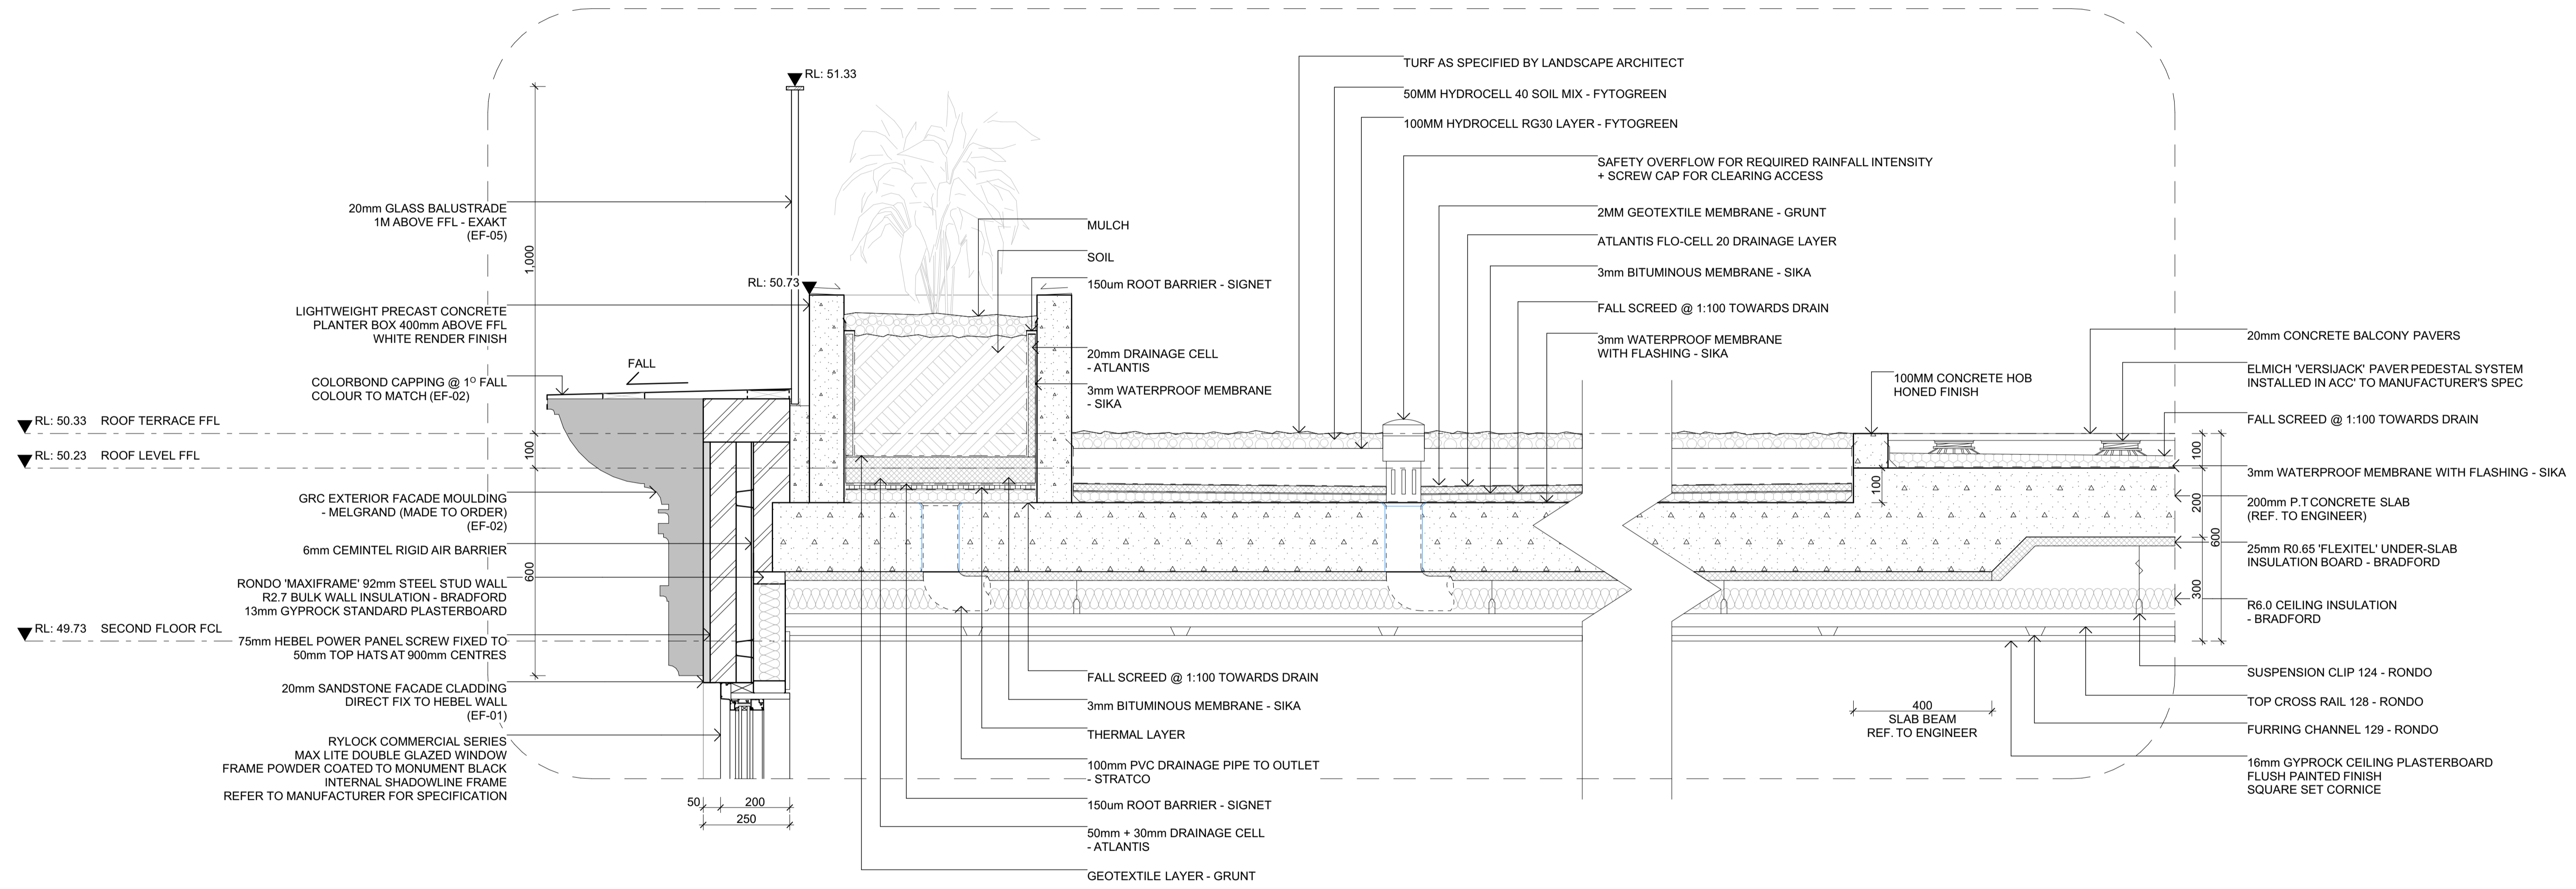

D-01 GREEN ROOF / TERRACE DETAIL
A06-02 1:10

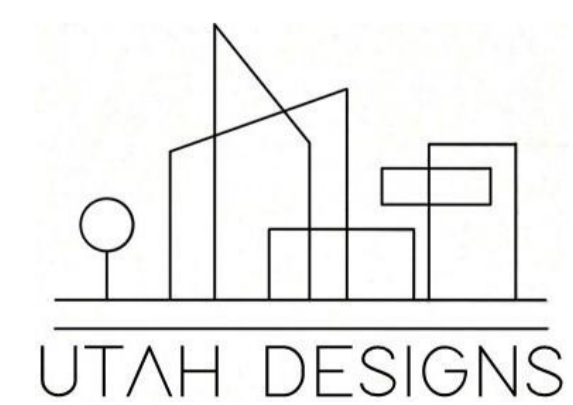

Rev	ChID	Description	Date
P		PRELIMINARY SUBMISSION	1/06/26
P		TR PRELIMINARY SUBMISSION	4/06/26
A	F	FINAL SUBMISSION	12/06/26

NOTES:
 THE BUILDER SHALL CHECK AND VERIFY ALL DIMENSIONS AND NOTIFY ALL ERRORS AND OMISSIONS TO THE DESIGNER.
 DO NOT SCALE DRAWINGS.
 USE FIGURED DIMENSIONS ONLY. DRAWINGS ARE NOT TO BE USED FOR CONSTRUCTION UNTIL ISSUED BY THE DESIGNER FOR CONSTRUCTION.
 STUDENT DECLARES THAT THIS ASSESSMENT TASK IS HER/HIS OWN WORK UNLESS OTHERWISE ACKNOWLEDGED AND IS IN ACCORDANCE WITH THE INSTITUTE'S PLAGIARISM POLICY. STUDENT ACKNOWLEDGES THAT THE ASSESSOR OF THIS ASSESSMENT TASK MAY:
 1. REPRODUCE THIS ASSESSMENT TASK AND PROVIDE A COPY TO ANOTHER MEMBER OF THE INSTITUTE OR DISPLAY THIS ASSESSMENT WITHIN THE INSTITUTE FOR EDUCATIONAL PURPOSES. 2. SUBMIT THE ASSESSMENT TASK TO PLAGIARISM CHECKING.

JAXON BELL
 100660344
 22477VIC
 Advanced Diploma of Building Design (Architectural)

AT4.2 APARTMENT BUILDING
 9-11 BEVIS STREET BENTLEIGH EAST
 VIC 3165 AUSTRALIA


DRAWING NAME:
 DETAILS SHEET 1 - GREEN ROOF/ TERRACE

FILE: WD_AT4.2_APARTMENT BUILDING.pln

DATE: 14/06/2026 **CHECKED:** TEACHER


DWG NO: A09-01 **REVISION:** A

SCALE: 1:10 **at** A1

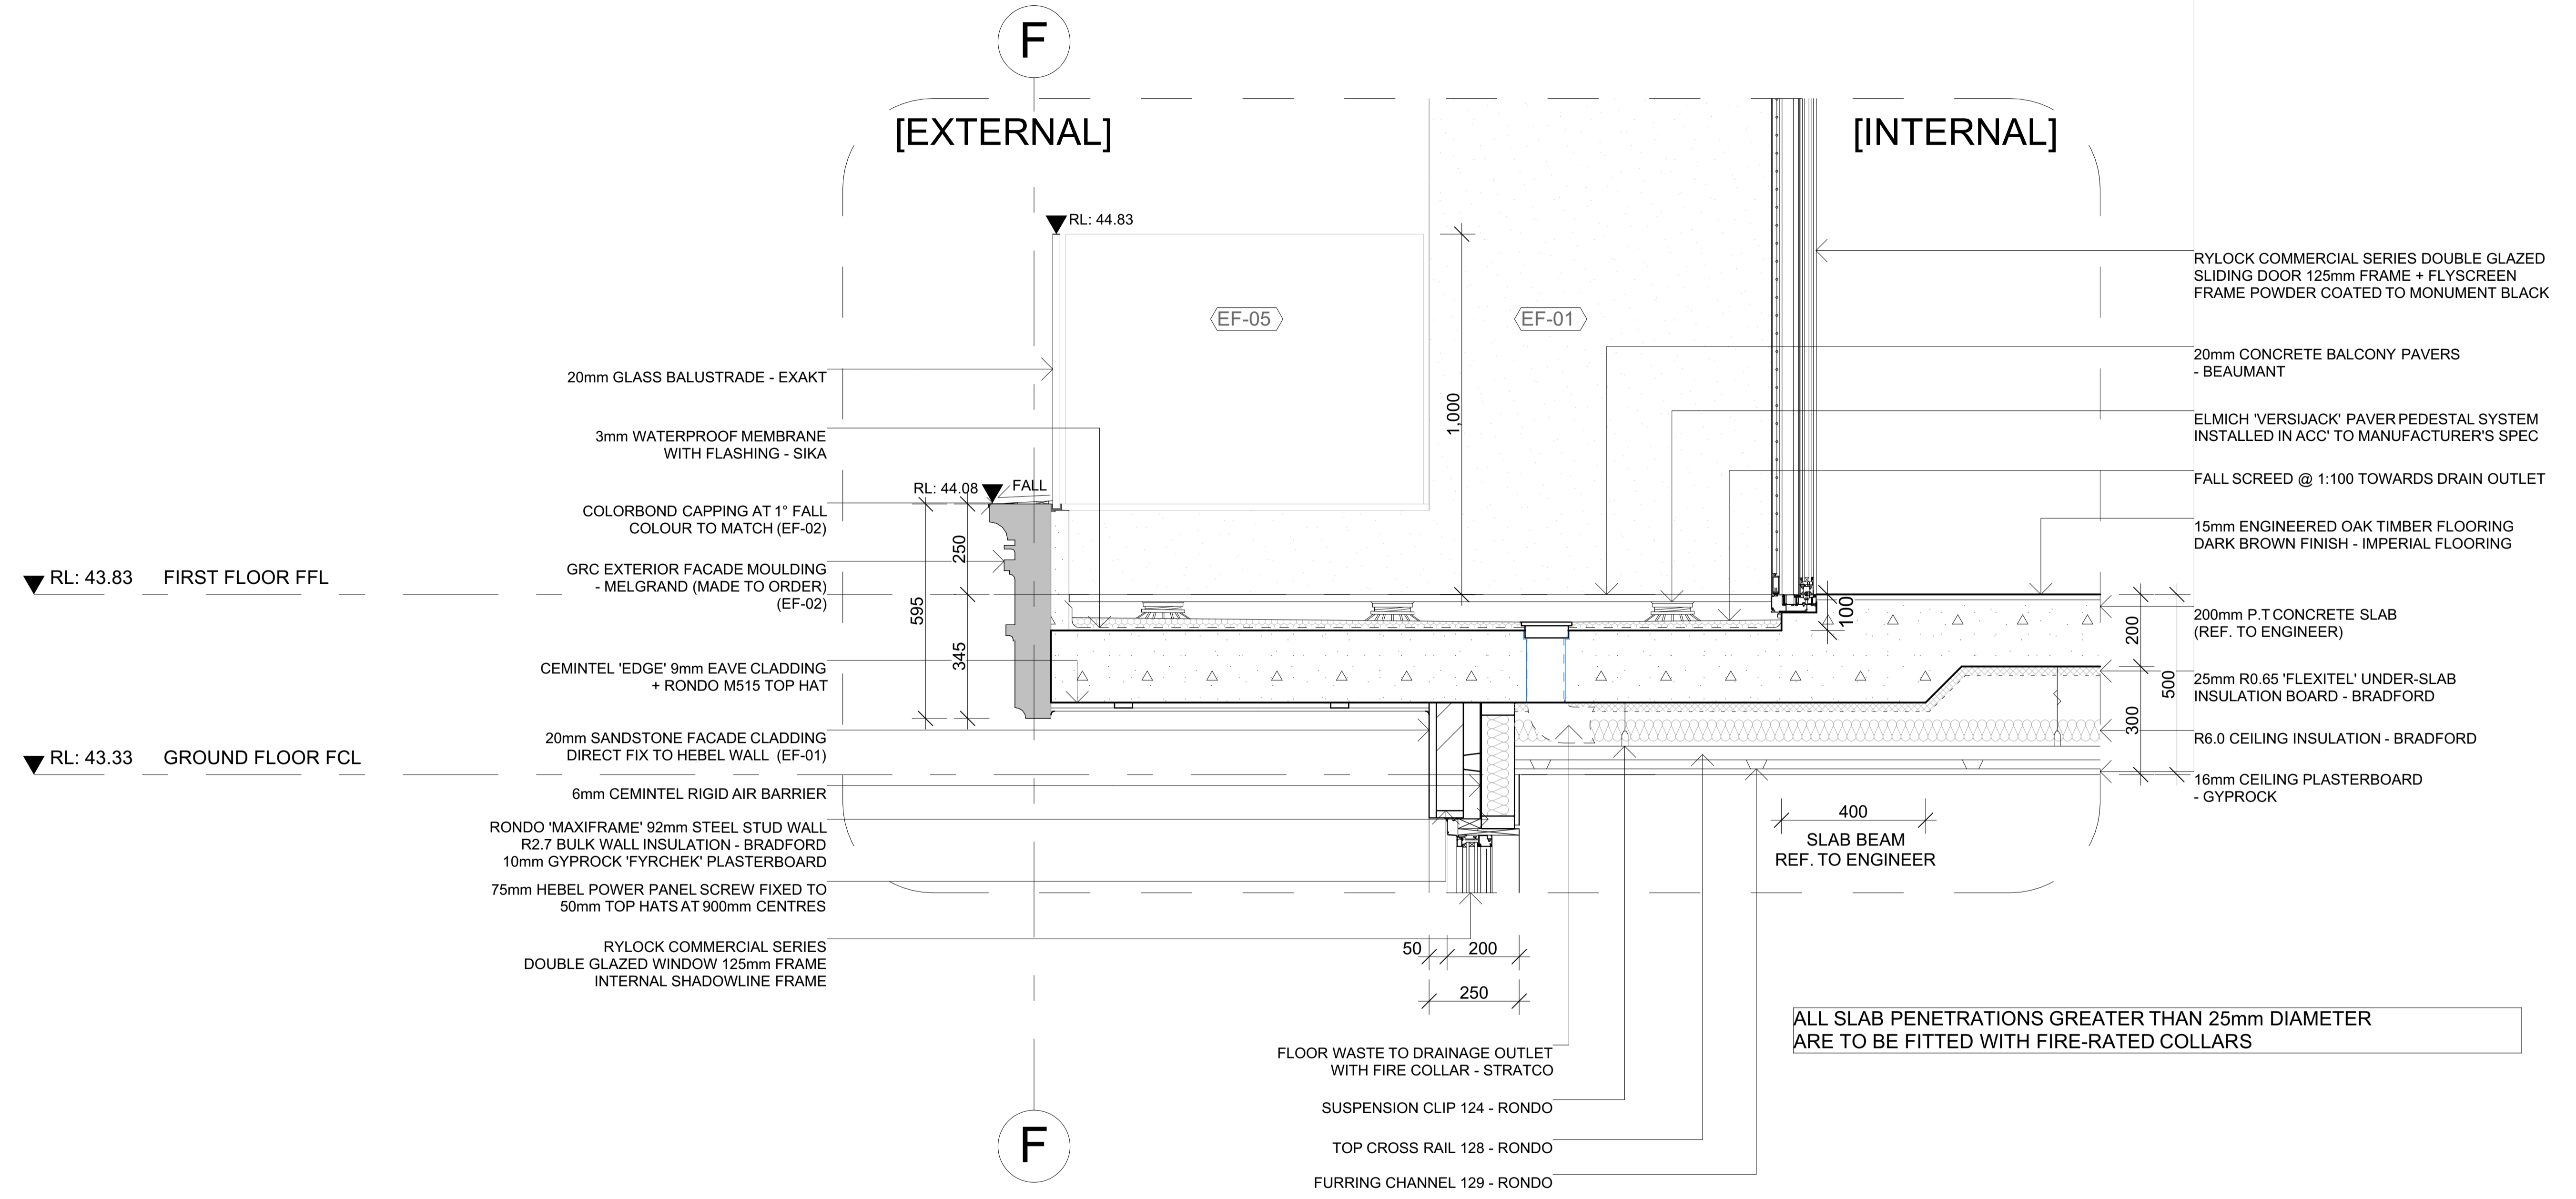

D-02
A02-03

TYPICAL BALCONY DETAIL
1:10

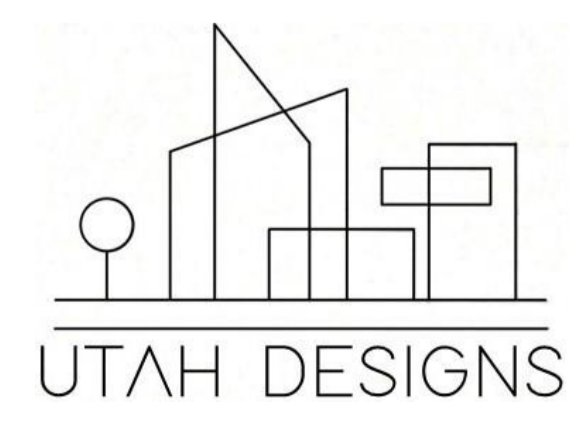

Rev	ChID	Description	Date
P		PRELIMINARY SUBMISSION	1/06/26
P		TR PRELIMINARY SUBMISSION	4/06/26
A	F	FINAL SUBMISSION	12/06/26

NOTES:
 THE BUILDER SHALL CHECK AND VERIFY ALL DIMENSIONS AND NOTIFY ALL ERRORS AND OMISSIONS TO THE DESIGNER.
 DO NOT SCALE DRAWINGS.
 USE FIGURED DIMENSIONS ONLY. DRAWINGS ARE NOT TO BE USED FOR CONSTRUCTION UNTIL ISSUED BY THE DESIGNER FOR CONSTRUCTION.

STUDENT DECLARES THAT THIS ASSESSMENT TASK IS HER/HIS OWN WORK UNLESS OTHERWISE ACKNOWLEDGED AND IS IN ACCORDANCE WITH THE INSTITUTE'S PLAGIARISM POLICY. STUDENT ACKNOWLEDGES THAT THE ASSESSOR OF THIS ASSESSMENT TASK MAY:
 1. REPRODUCE THIS ASSESSMENT TASK AND PROVIDE A COPY TO ANOTHER MEMBER OF THE INSTITUTE OR DISPLAY THIS ASSESSMENT WITHIN THE INSTITUTE FOR EDUCATIONAL PURPOSES. 2. SUBMIT THE ASSESSMENT TASK TO PLAGIARISM CHECKING.

JAXON BELL
 100660344
 22477VIC
 Advanced Diploma of Building Design (Architectural)

AT4.2 APARTMENT BUILDING
 9-11 BEVIS STREET BENTLEIGH EAST
 VIC 3165 AUSTRALIA


DRAWING NAME:
 DETAILS SHEET 2 - TYPICAL BALCONY

FILE: WD_AT4.2_APARTMENT BUILDING.pln


DATE: 14/06/2026 CHECKED: TEACHER

DWG NO: **A09-02** REVISION: **A**


SCALE: 1:10 at A1

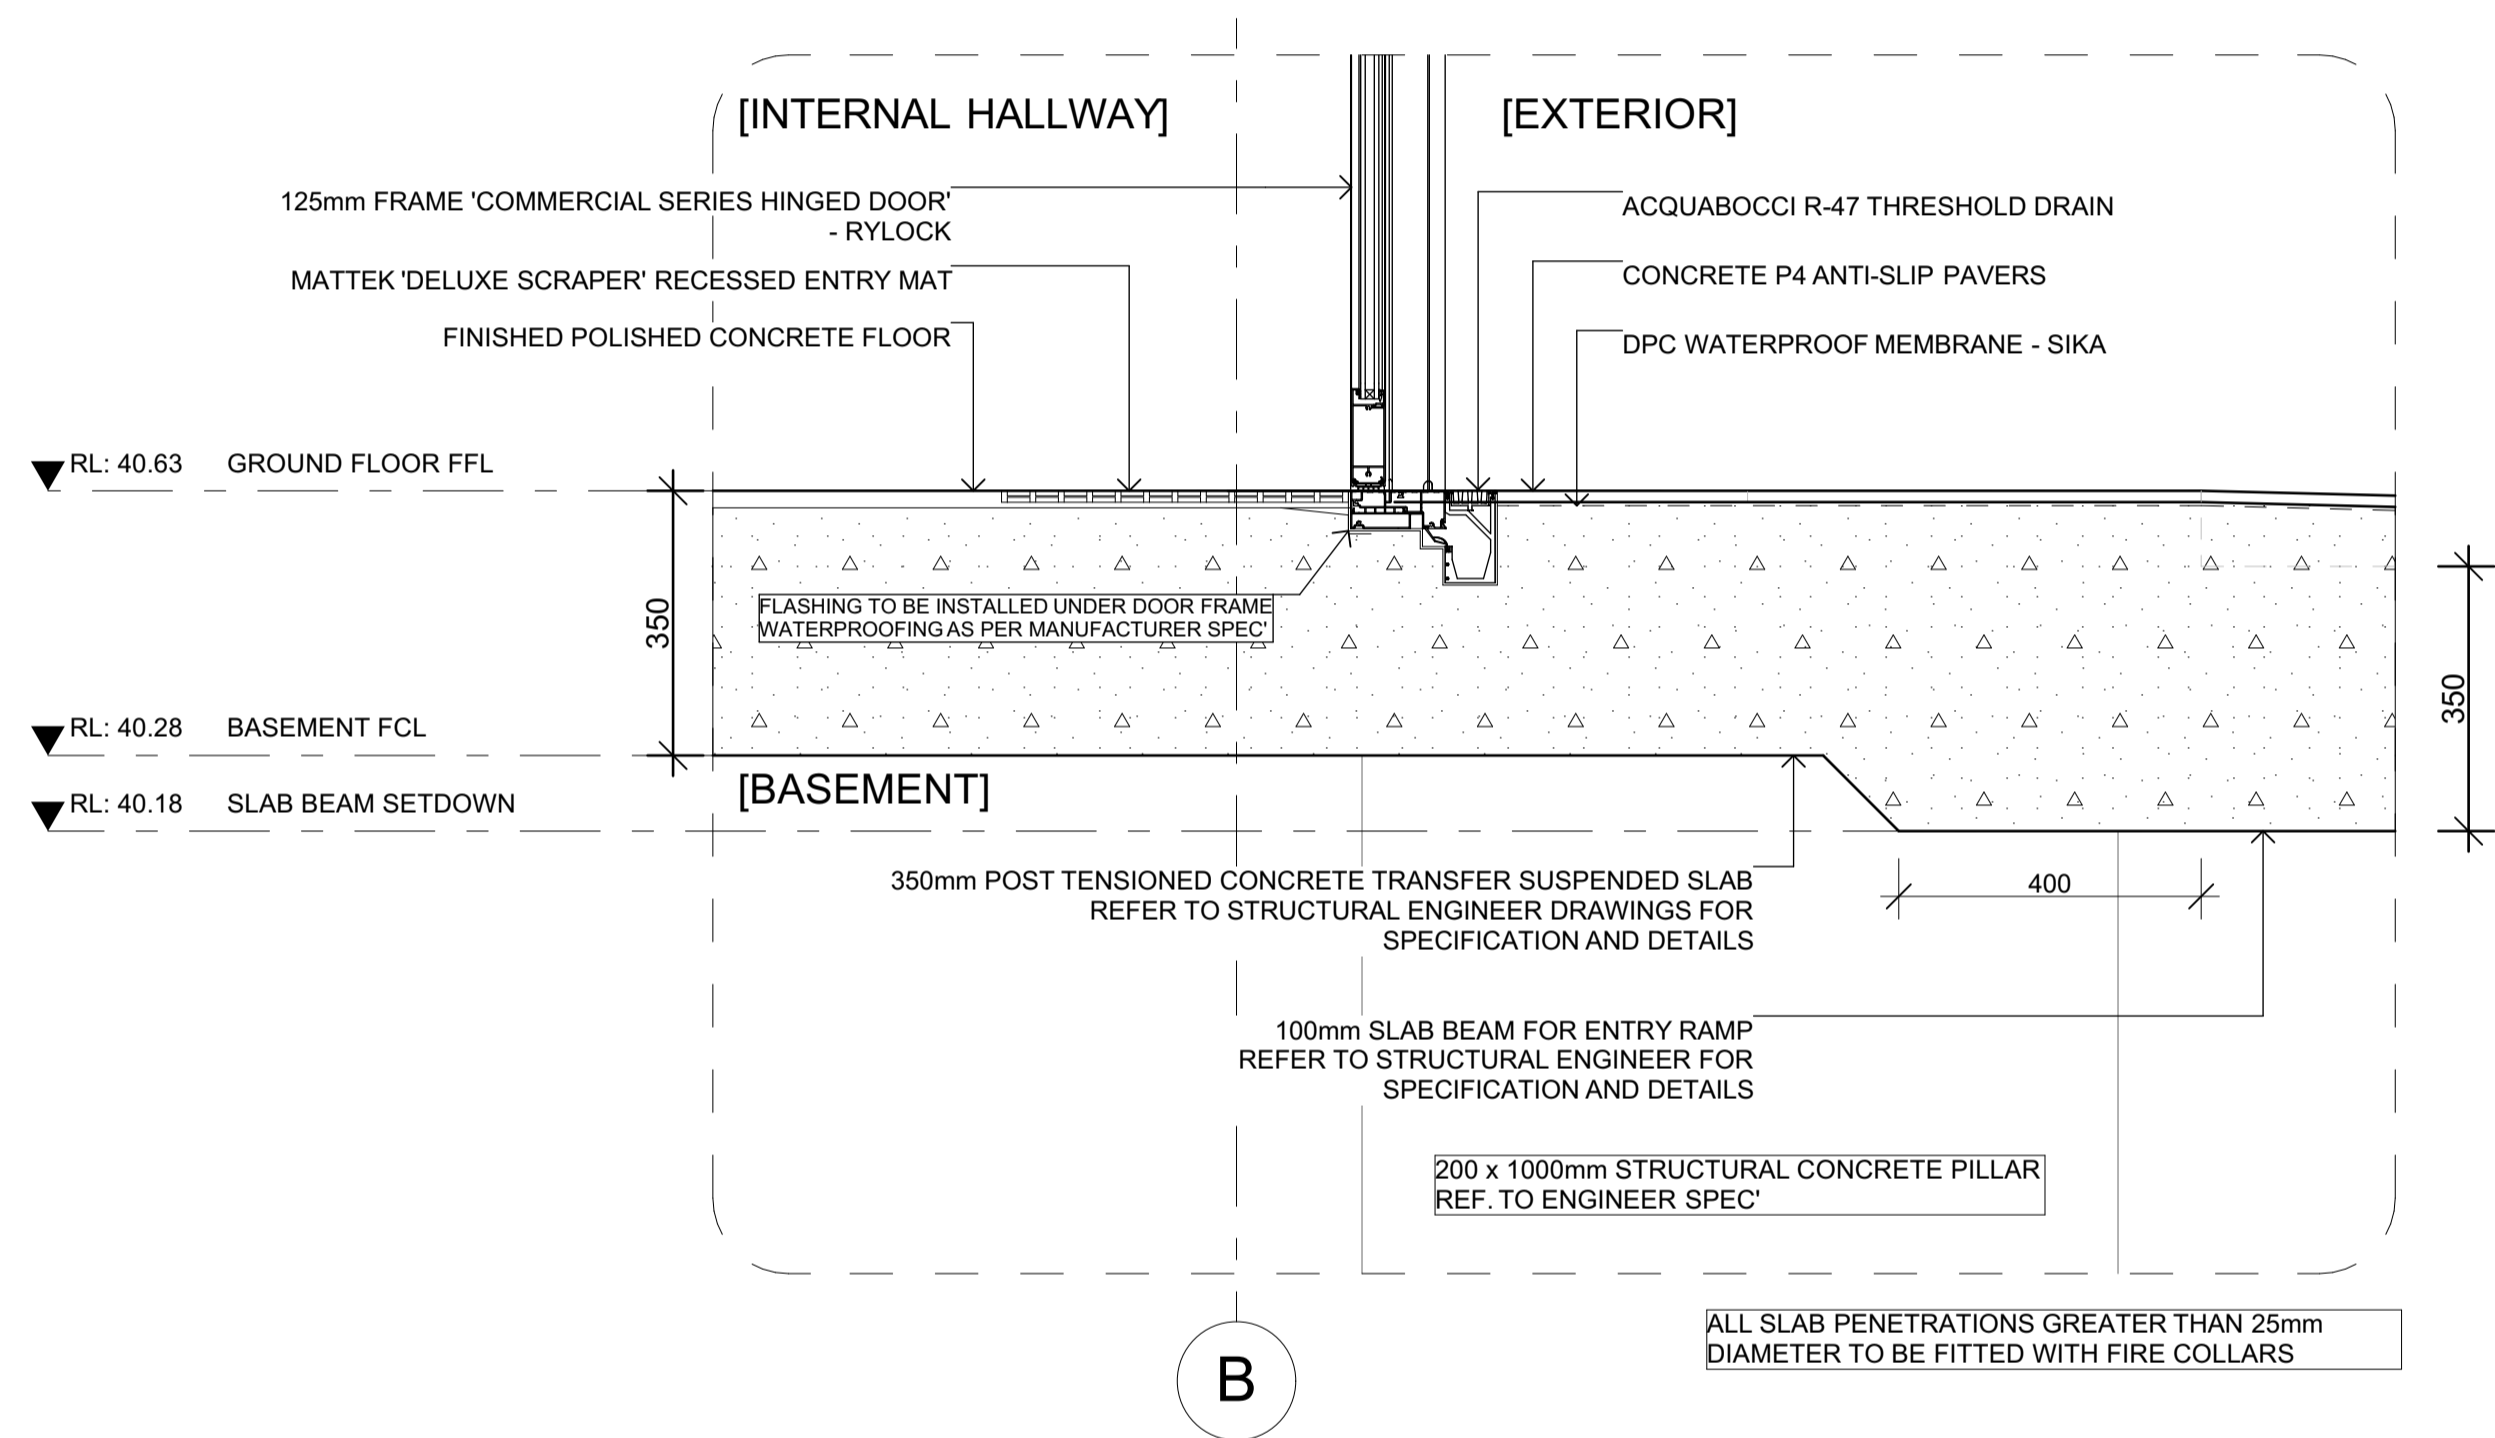

D-03
A06-03
GROUND FLOOR ENTRY DETAIL
1:10

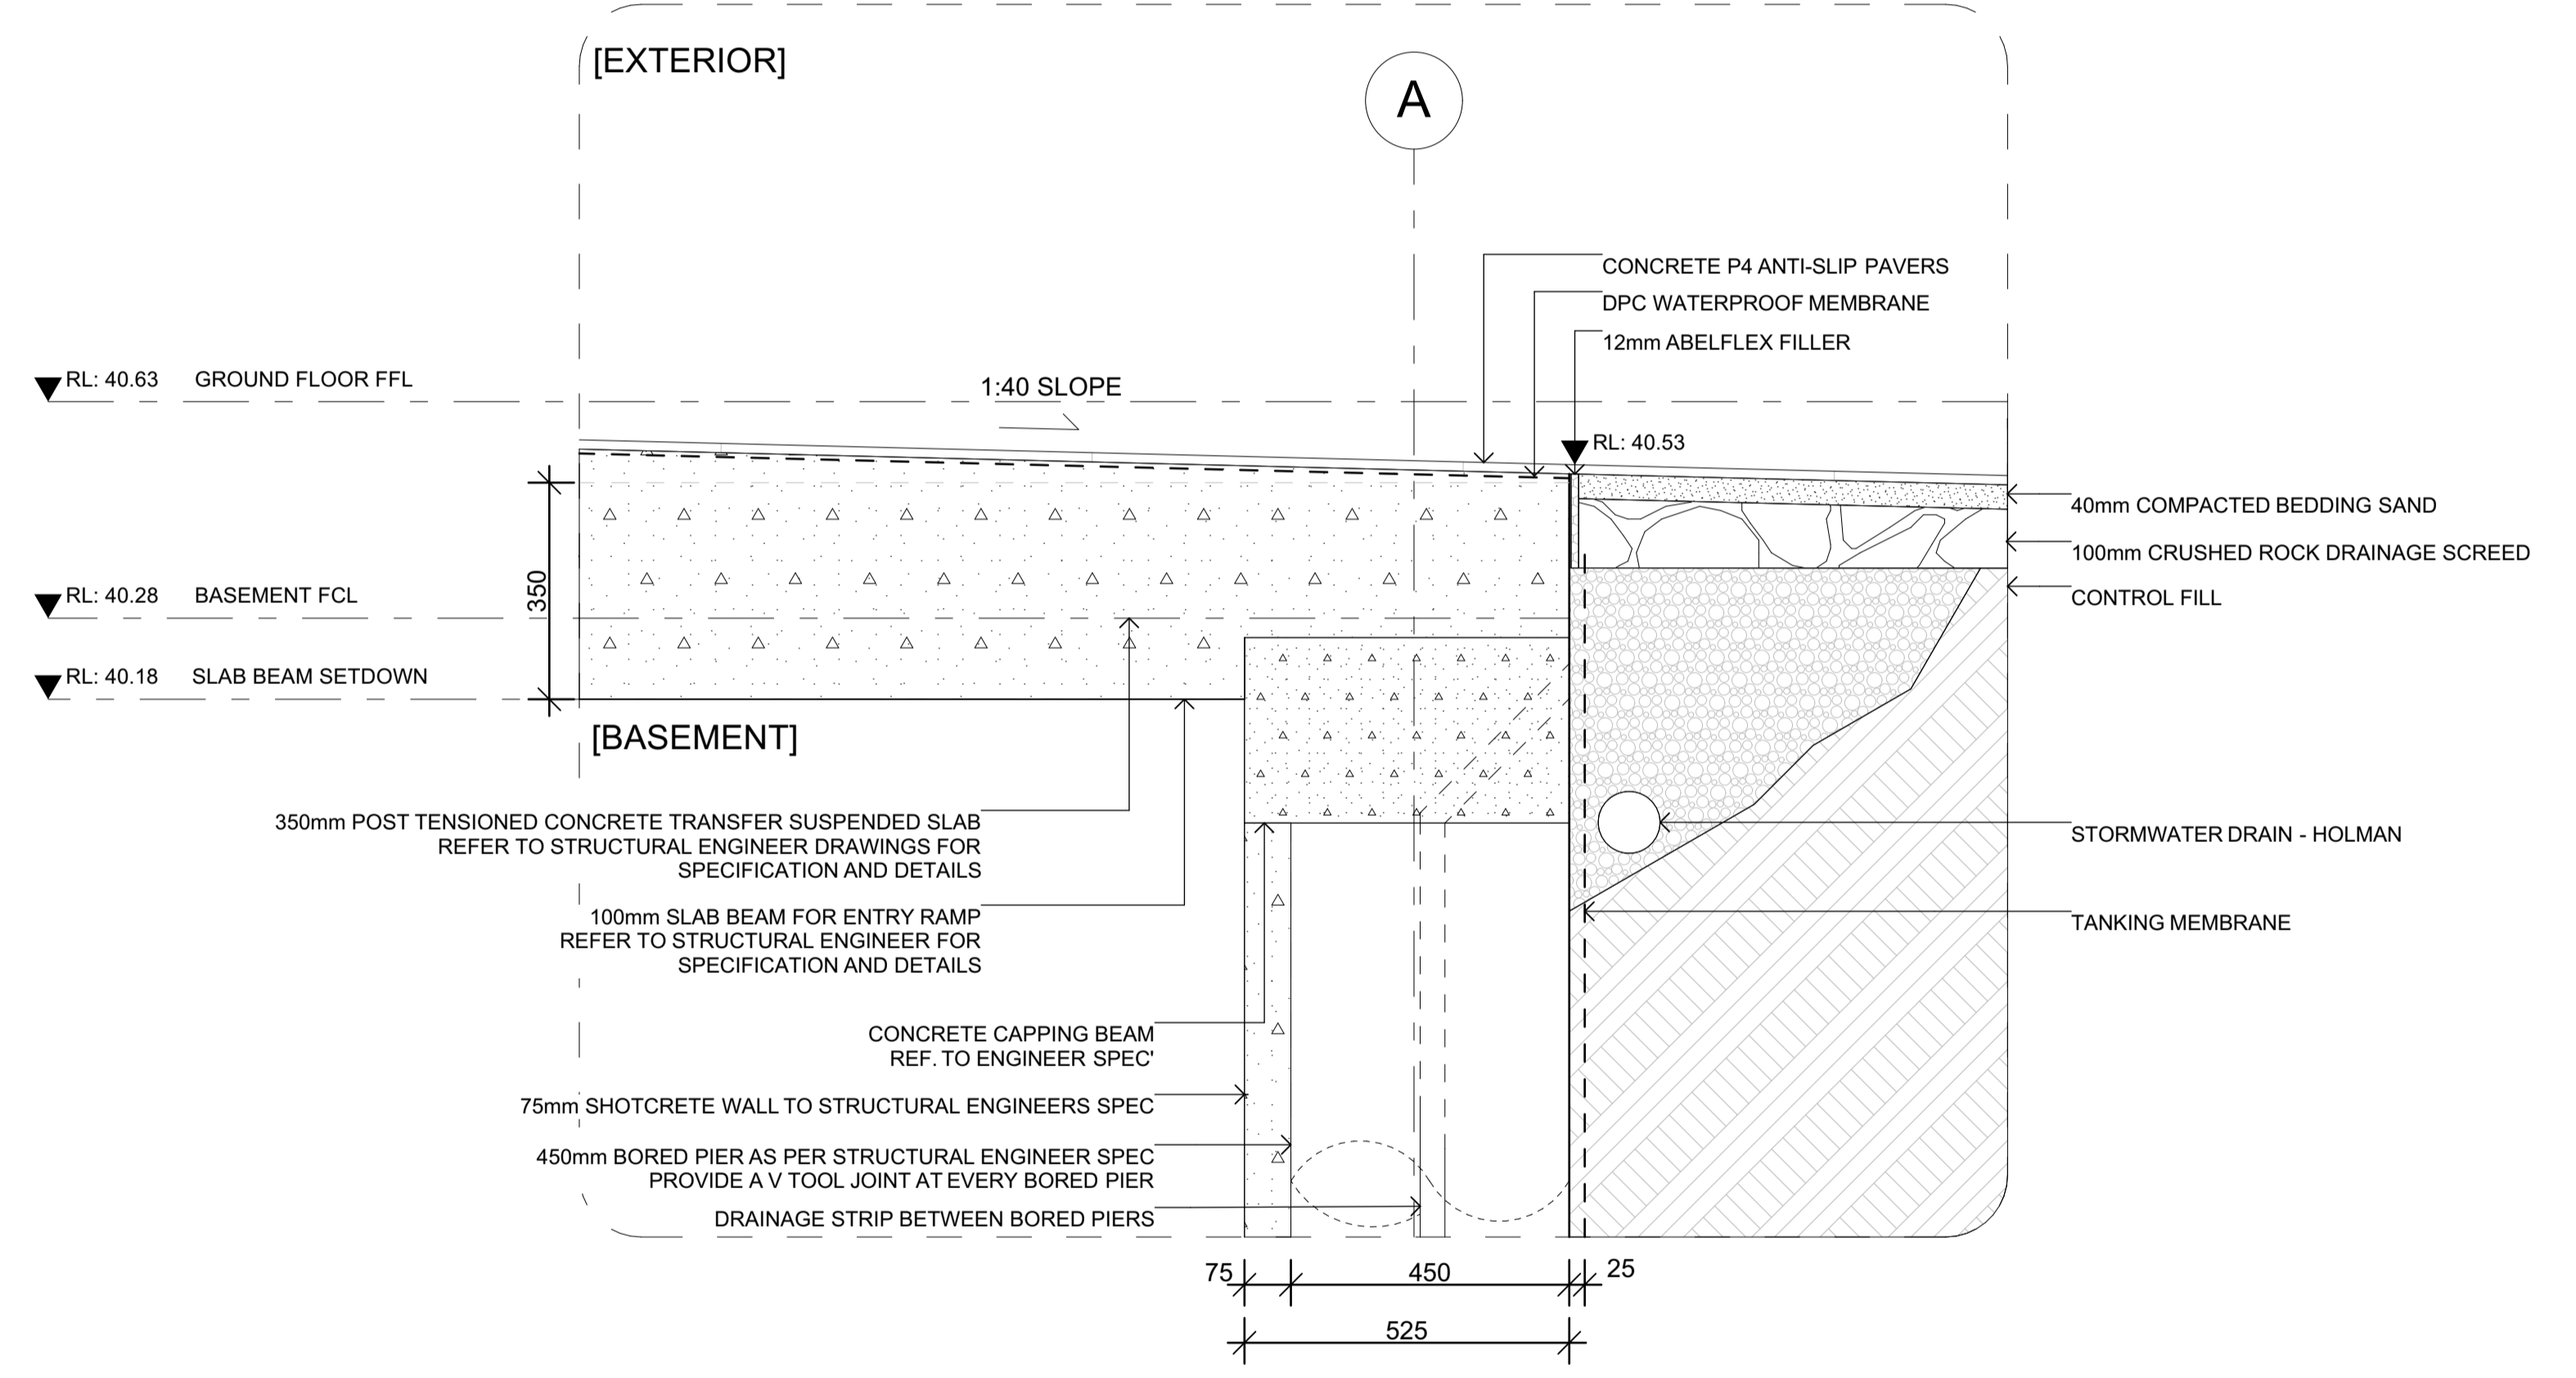

D-04
A06-03
GROUND FLOOR/ BASEMENT WALL DETAIL
1:10

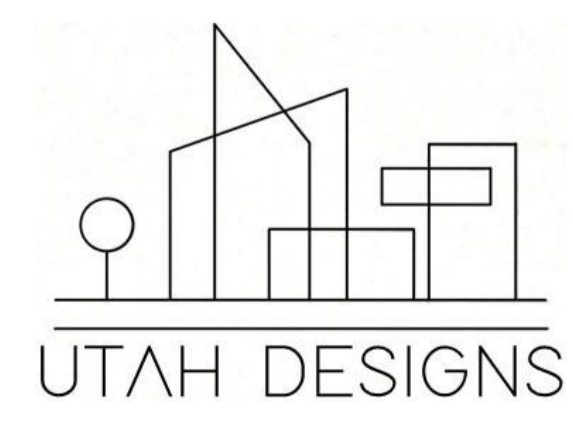

Rev	ChID	Description	Date
P		PRELIMINARY SUBMISSION	1/06/26
P		TR PRELIMINARY SUBMISSION	4/06/26
A		FINAL SUBMISSION	12/06/26


NOTES:
 THE BUILDER SHALL CHECK AND VERIFY ALL DIMENSIONS AND NOTIFY ALL ERRORS AND OMISSIONS TO THE DESIGNER.
 DO NOT SCALE DRAWINGS.
 USE FIGURED DIMENSIONS ONLY. DRAWINGS ARE NOT TO BE USED FOR CONSTRUCTION UNTIL ISSUED BY THE DESIGNER FOR CONSTRUCTION.
 STUDENT DECLARES THAT THIS ASSESSMENT TASK IS HER/HIS OWN WORK UNLESS OTHERWISE ACKNOWLEDGED AND IS IN ACCORDANCE WITH THE INSTITUTE'S PLAGIARISM POLICY. STUDENT ACKNOWLEDGES THAT THE ASSESSOR OF THIS ASSESSMENT TASK MAY:
 1. REPRODUCE THIS ASSESSMENT TASK AND PROVIDE A COPY TO ANOTHER MEMBER OF THE INSTITUTE OR DISPLAY THIS ASSESSMENT WITHIN THE INSTITUTE FOR EDUCATIONAL PURPOSES. 2. SUBMIT THE ASSESSMENT TASK TO PLAGIARISM CHECKING.

JAXON BELL
 100660344
 22477VIC
 Advanced Diploma of Building Design (Architectural)

AT4.2 APARTMENT BUILDING
 9-11 BEVIS STREET BENTLEIGH EAST
 VIC 3165 AUSTRALIA


DRAWING NAME:
 DETAILS SHEET 3 - GROUND/ ENTRY
FILE: WD_AT4.2_APARTMENT BUILDING.pln
DATE: 14/06/2026
CHECKED: TEACHER

DWG NO: A09-03
REVISION: A
SCALE: 1:10
at A1

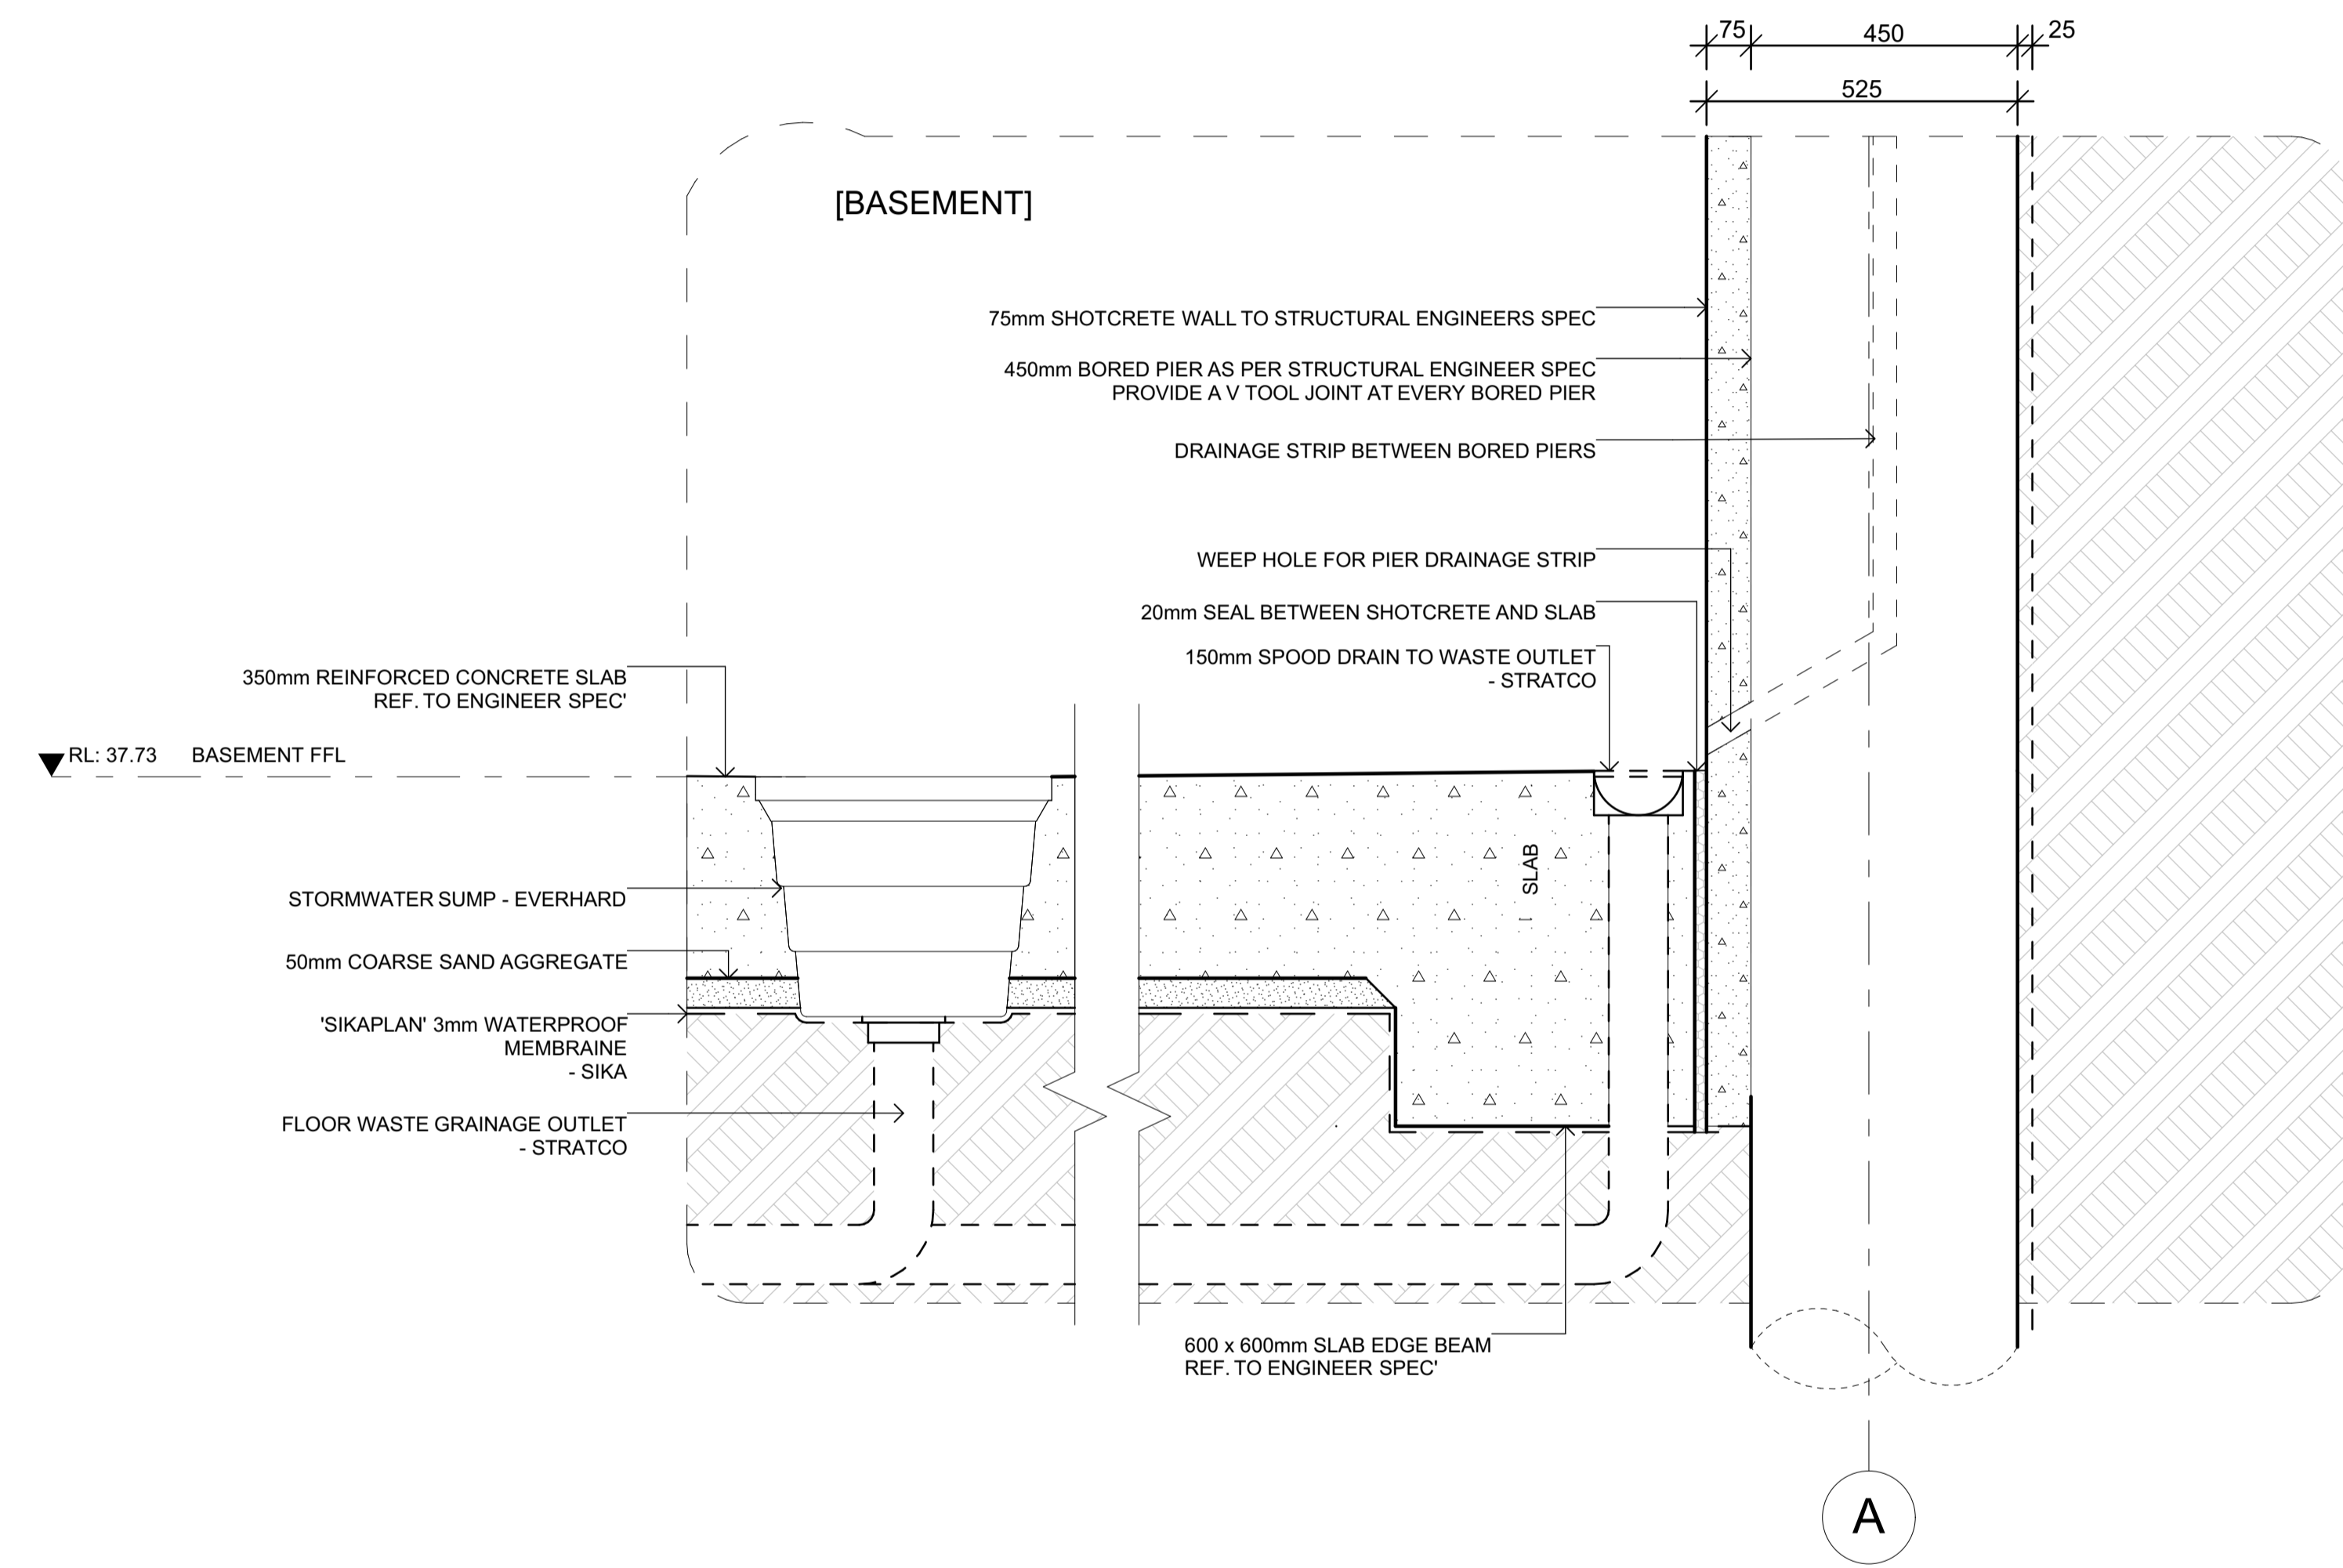

D-05
A06-03

BASEMENT SLAB DETAIL
1:10

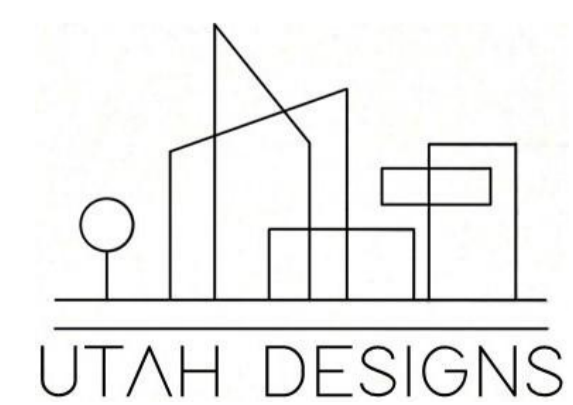

Rev	ChID	Description	Date
P		PRELIMINARY SUBMISSION	1/06/26
P		TR PRELIMINARY SUBMISSION	4/06/26
A	F	FINAL SUBMISSION	12/06/26

NOTES:
 THE BUILDER SHALL CHECK AND VERIFY ALL DIMENSIONS AND NOTIFY ALL ERRORS AND OMISSIONS TO THE DESIGNER.
 DO NOT SCALE DRAWINGS.
 USE FIGURED DIMENSIONS ONLY. DRAWINGS ARE NOT TO BE USED FOR CONSTRUCTION UNTIL ISSUED BY THE DESIGNER FOR CONSTRUCTION.

STUDENT DECLARES THAT THIS ASSESSMENT TASK IS HER/HIS OWN WORK UNLESS OTHERWISE ACKNOWLEDGED AND IS IN ACCORDANCE WITH THE INSTITUTE'S PLAGIARISM POLICY. STUDENT ACKNOWLEDGES THAT THE ASSESSOR OF THIS ASSESSMENT TASK MAY:
 1. REPRODUCE THIS ASSESSMENT TASK AND PROVIDE A COPY TO ANOTHER MEMBER OF THE INSTITUTE OR DISPLAY THIS ASSESSMENT WITHIN THE INSTITUTE FOR EDUCATIONAL PURPOSES. 2. SUBMIT THE ASSESSMENT TASK TO PLAGIARISM CHECKING.

JAXON BELL
 100660344
 22477VIC

Advanced Diploma of Building Design (Architectural)

AT4.2 APARTMENT BUILDING
 9-11 BEVIS STREET BENTLEIGH EAST
 VIC 3165 AUSTRALIA


DRAWING NAME:
 DETAILS SHEET 4 - BASEMENT SLAB

FILE: WD_AT4.2_APARTMENT BUILDING.pln

DATE: 14/06/2026 CHECKED: TEACHER


DWG NO: **A09-04** REVISION: **A**

SCALE: 1:10 at A1

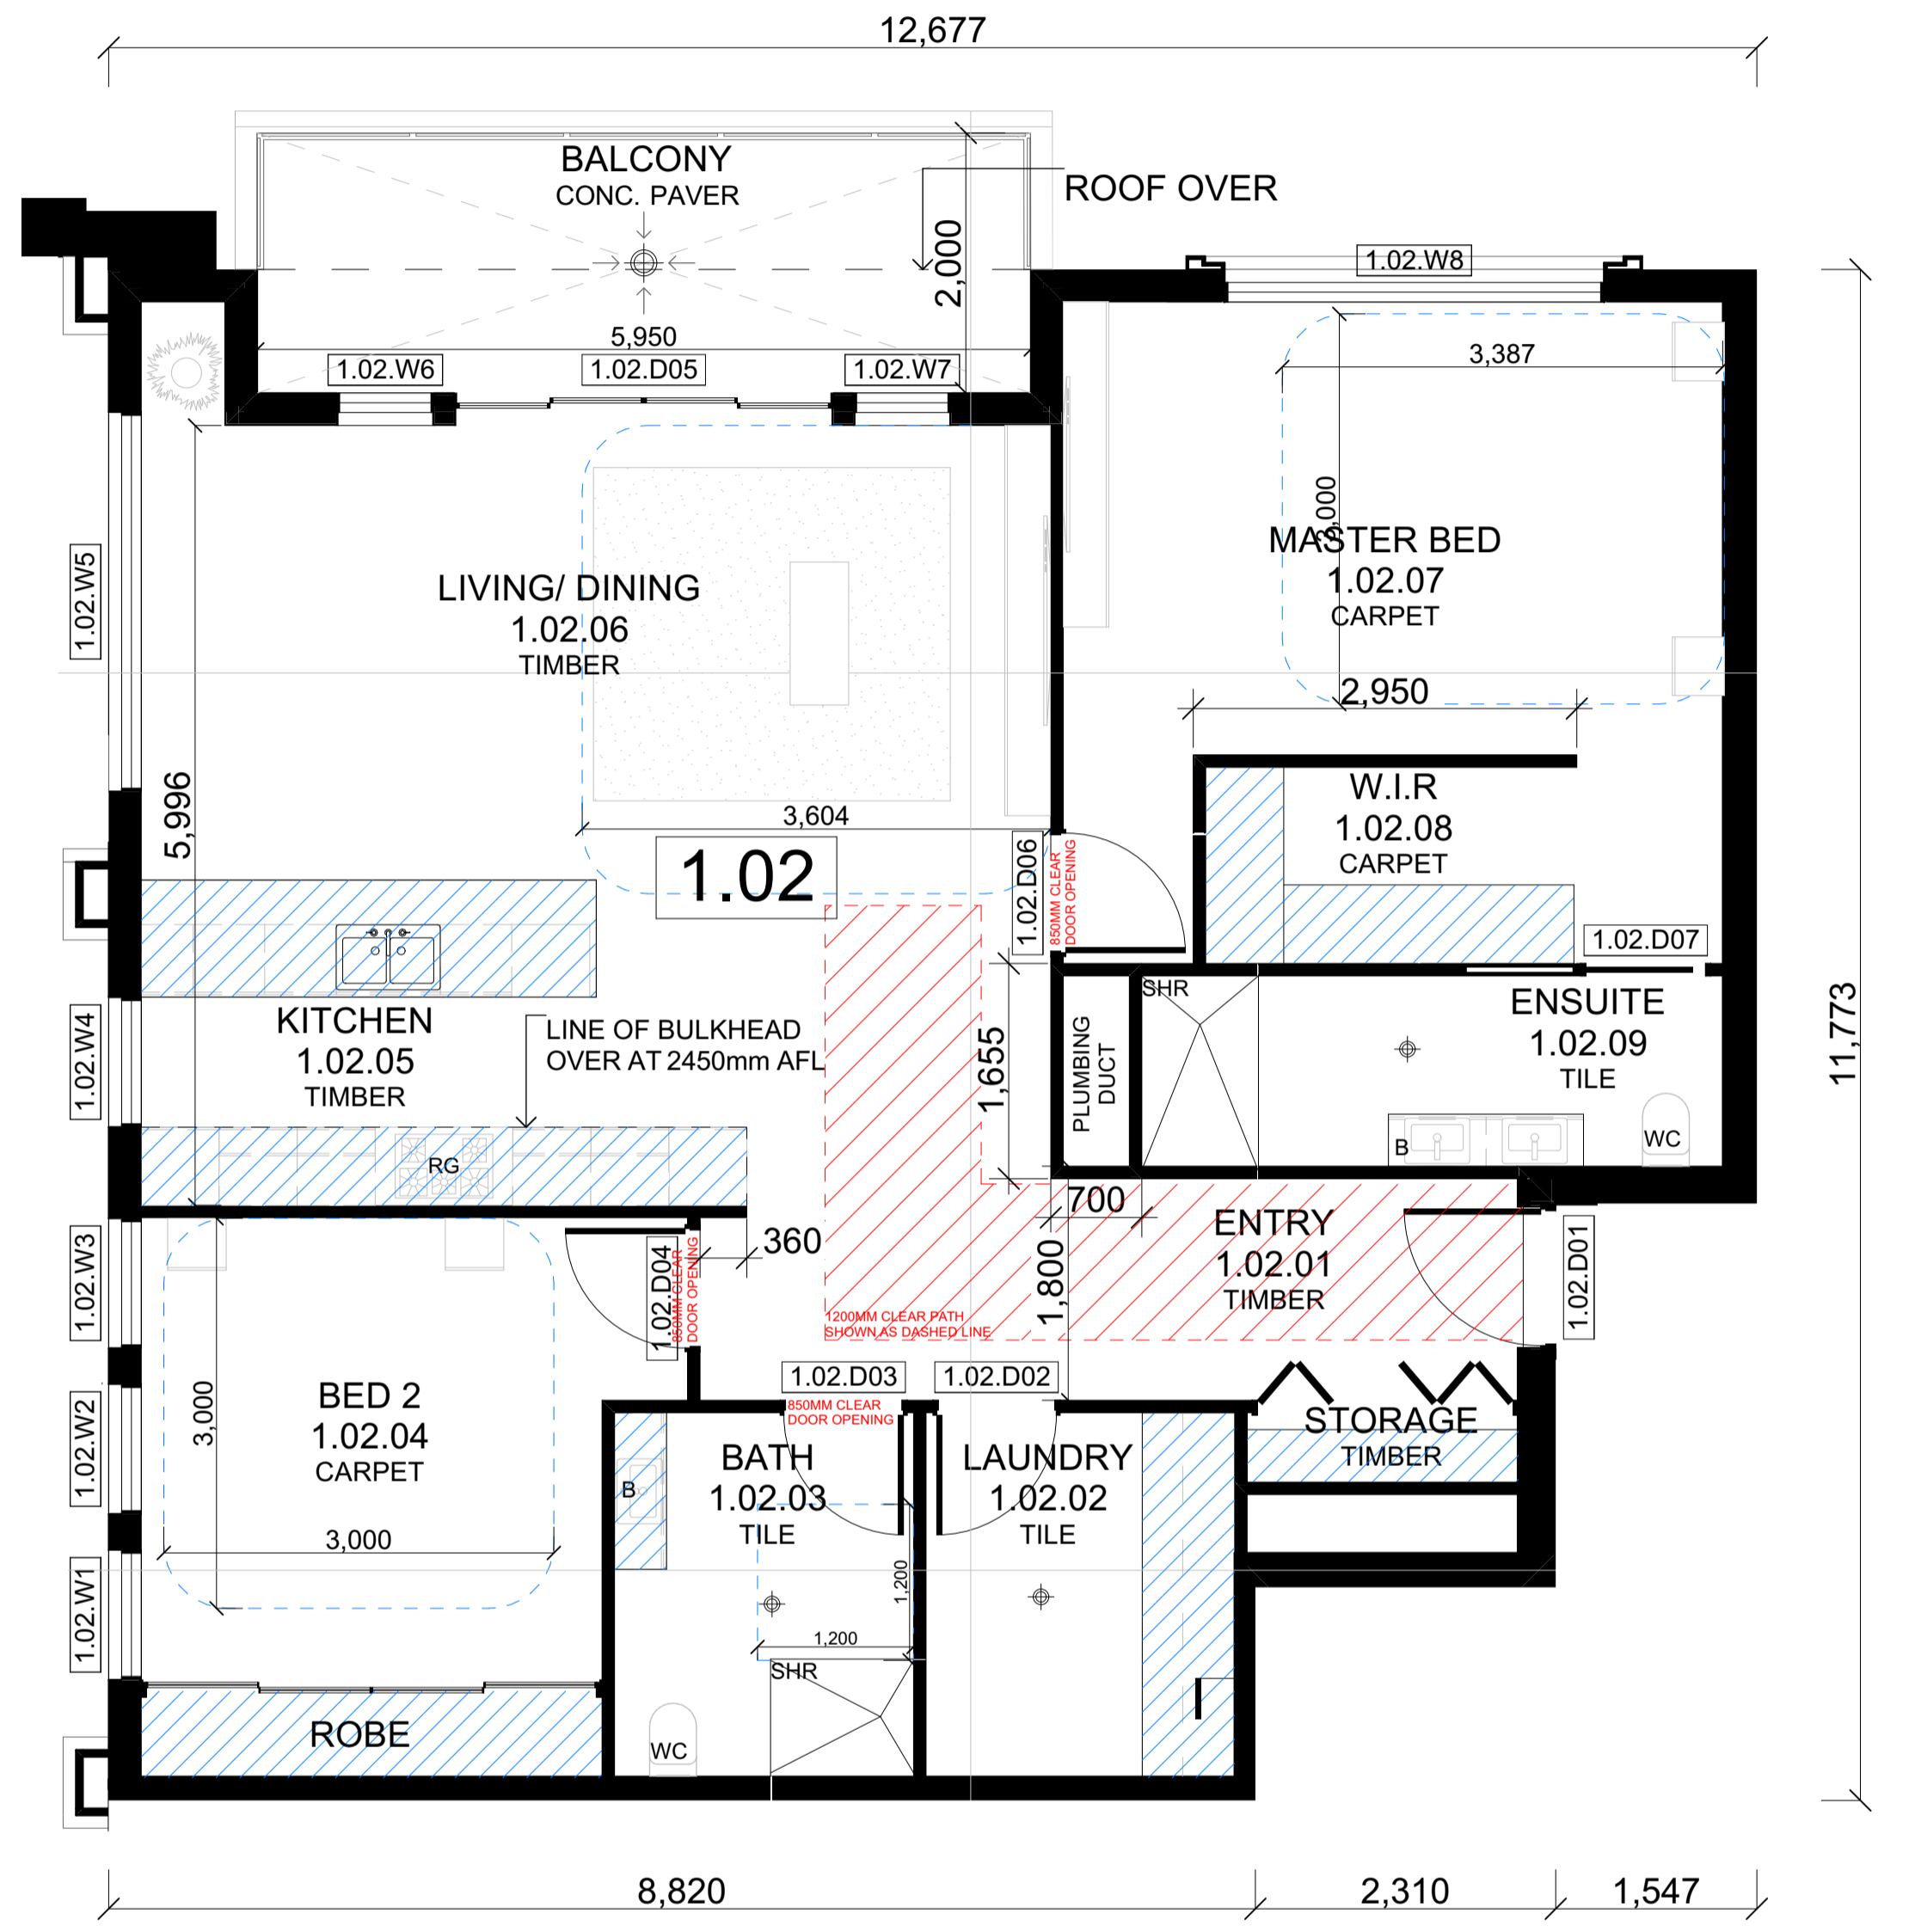

A15-01
A02-03

APARTMENT 1.02 FLOOR PLAN
1:50

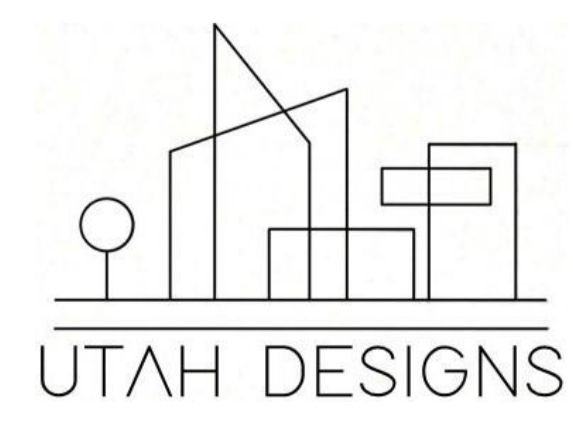

Rev	ChID	Description	Date
P		TR PRELIMINARY SUBMISSION	4/06/26
A	F	FINAL SUBMISSION	12/06/26

NOTES:
 THE BUILDER SHALL CHECK AND VERIFY ALL DIMENSIONS AND NOTIFY ALL ERRORS AND OMISSIONS TO THE DESIGNER.
 DO NOT SCALE DRAWINGS.
 USE FIGURED DIMENSIONS ONLY. DRAWINGS ARE NOT TO BE USED FOR CONSTRUCTION UNTIL ISSUED BY THE DESIGNER FOR CONSTRUCTION.

STUDENT DECLARES THAT THIS ASSESSMENT TASK IS HER/HIS OWN WORK UNLESS OTHERWISE ACKNOWLEDGED AND IS IN ACCORDANCE WITH THE INSTITUTE'S PLAGIARISM POLICY. STUDENT ACKNOWLEDGES THAT THE ASSESSOR OF THIS ASSESSMENT TASK MAY:
 1. REPRODUCE THIS ASSESSMENT TASK AND PROVIDE A COPY TO ANOTHER MEMBER OF THE INSTITUTE OR DISPLAY THIS ASSESSMENT WITHIN THE INSTITUTE FOR EDUCATIONAL PURPOSES. 2. SUBMIT THE ASSESSMENT TASK TO PLAGIARISM CHECKING.

JAXON BELL
 100660344
 22477VIC

Advanced Diploma of Building Design (Architectural)

AT4.2 APARTMENT BUILDING
 9-11 BEVIS STREET BENTLEIGH EAST
 VIC 3165 AUSTRALIA


DRAWING NAME:
 KEY INTERNAL AREAS - APARTMENT FITOUT

FILE: WD_AT4.2_APARTMENT BUILDING.pln


DATE: 14/06/2026 CHECKED: TEACHER

DWG NO: **A15-01** REVISION: **A**


SCALE: 1:50 at A1

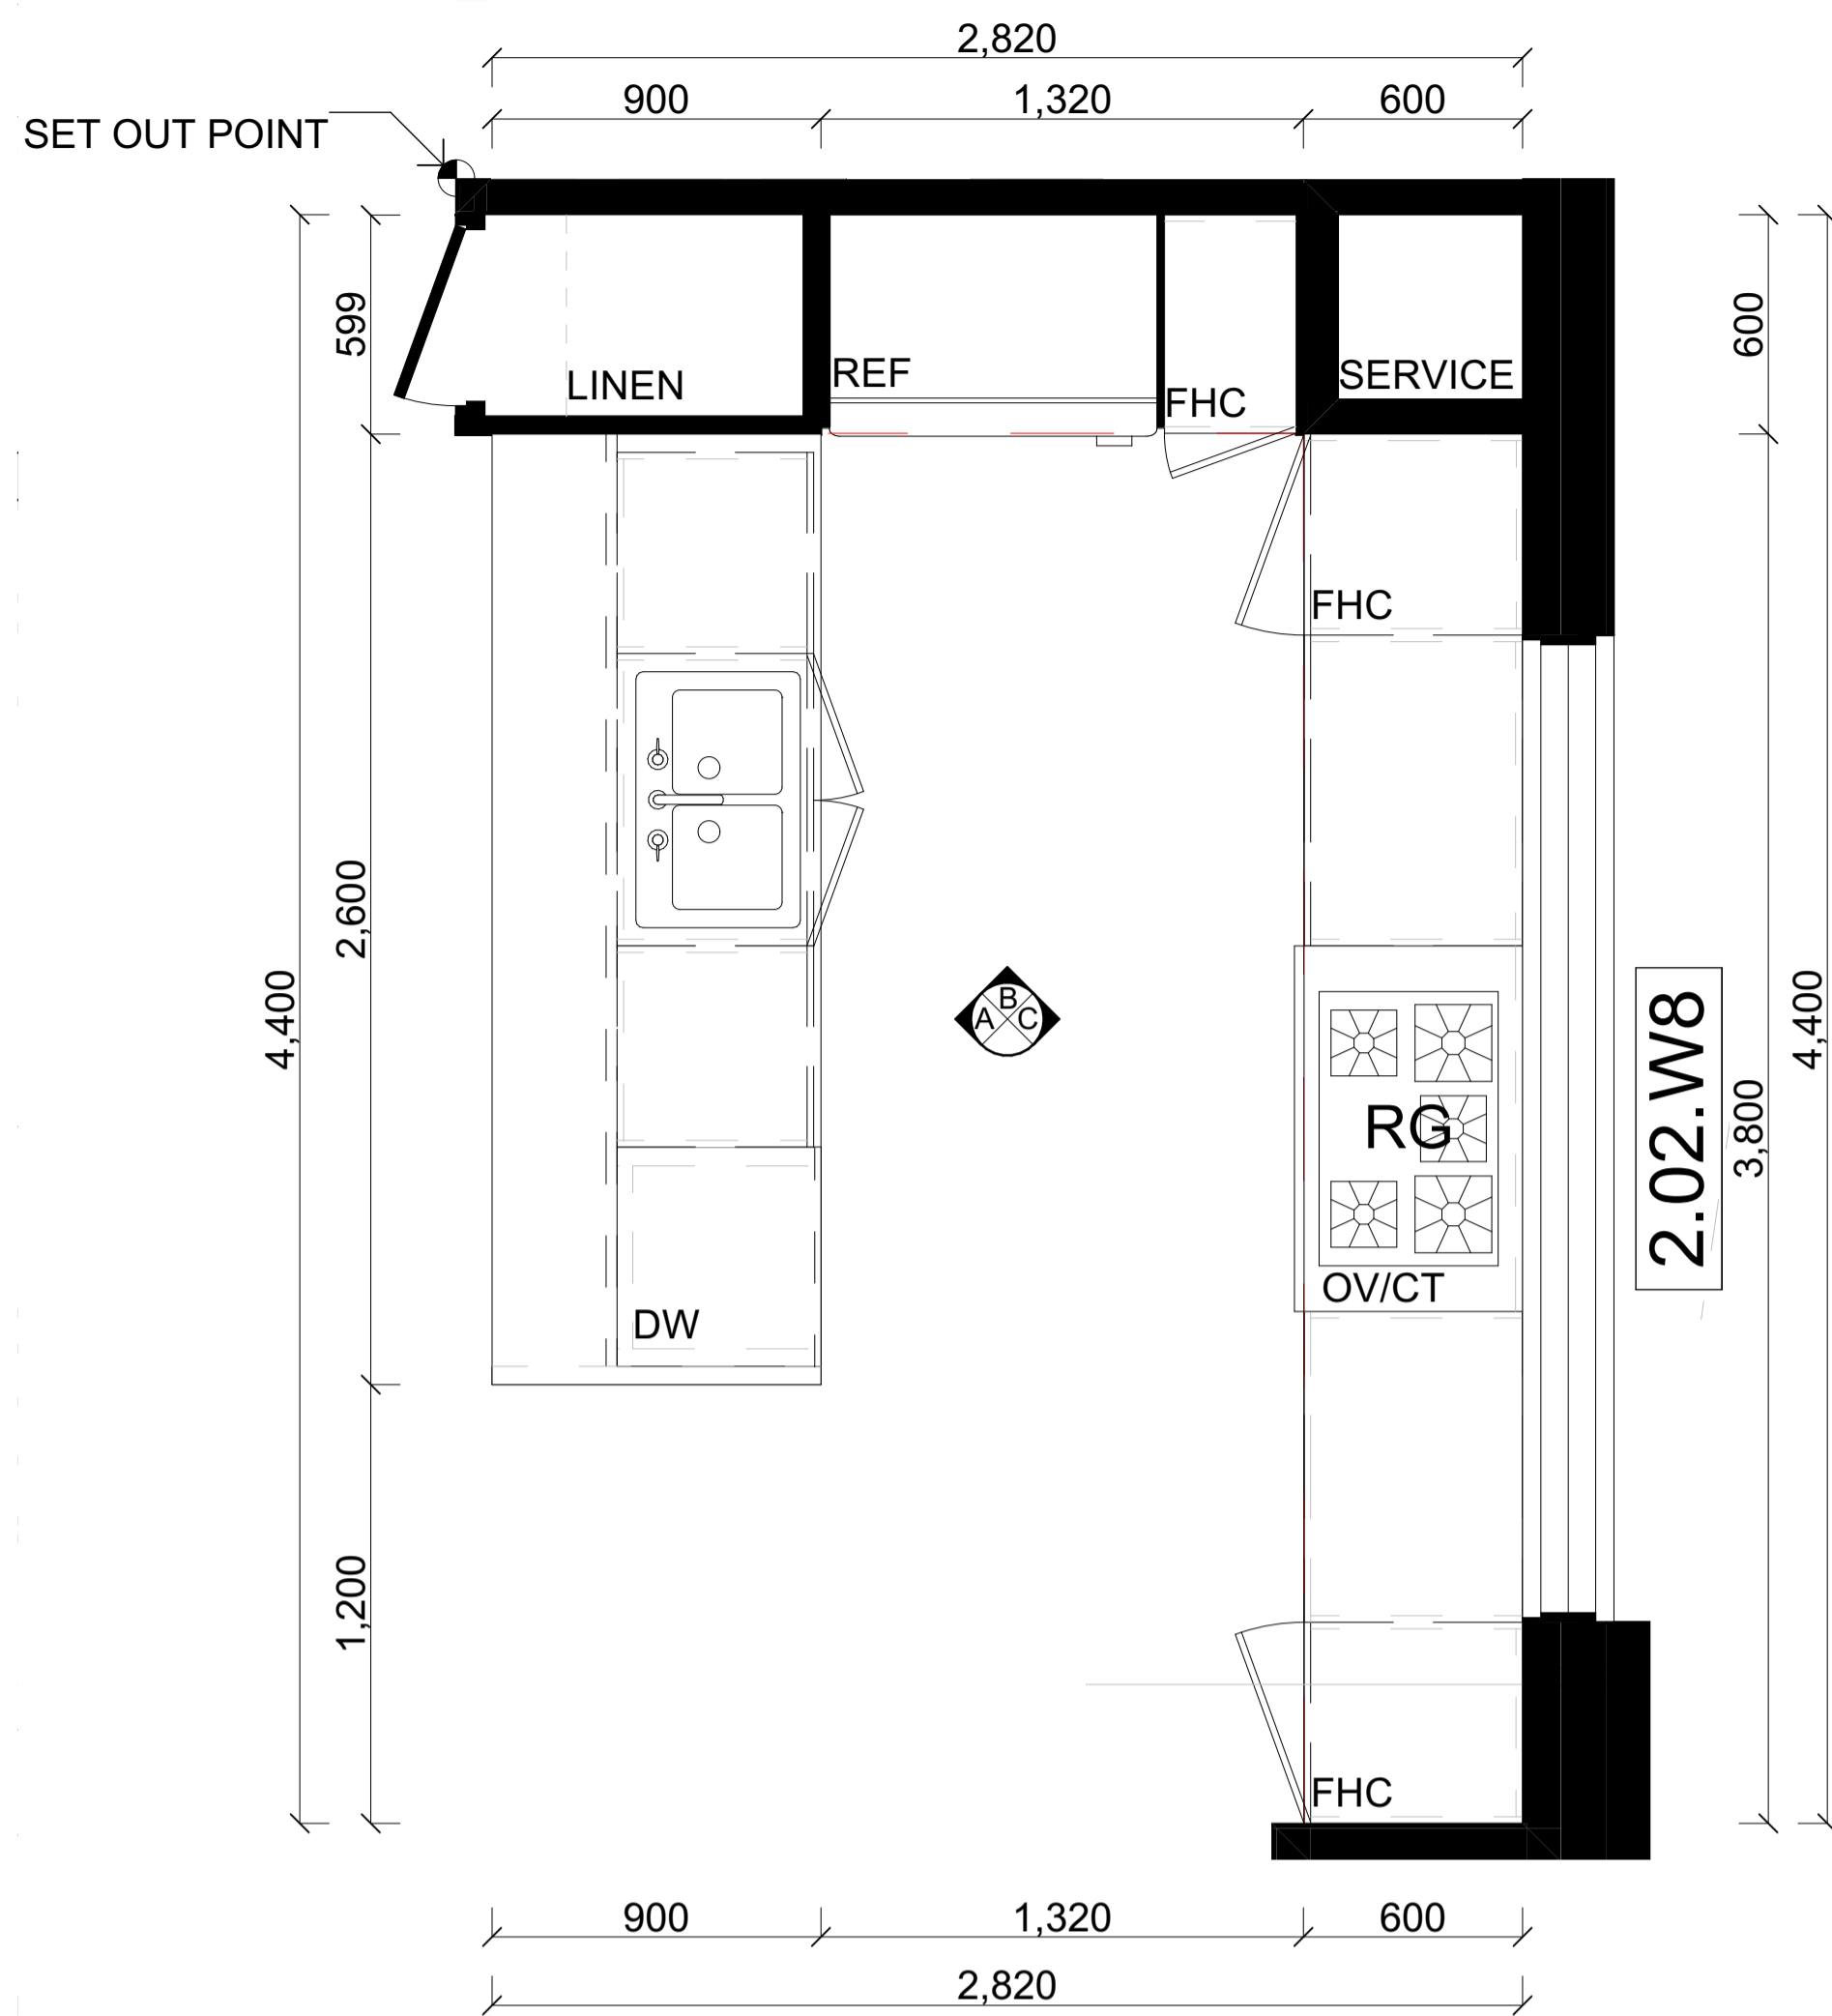


K-F
A02-04 KITCHEN FITOUT 1:20

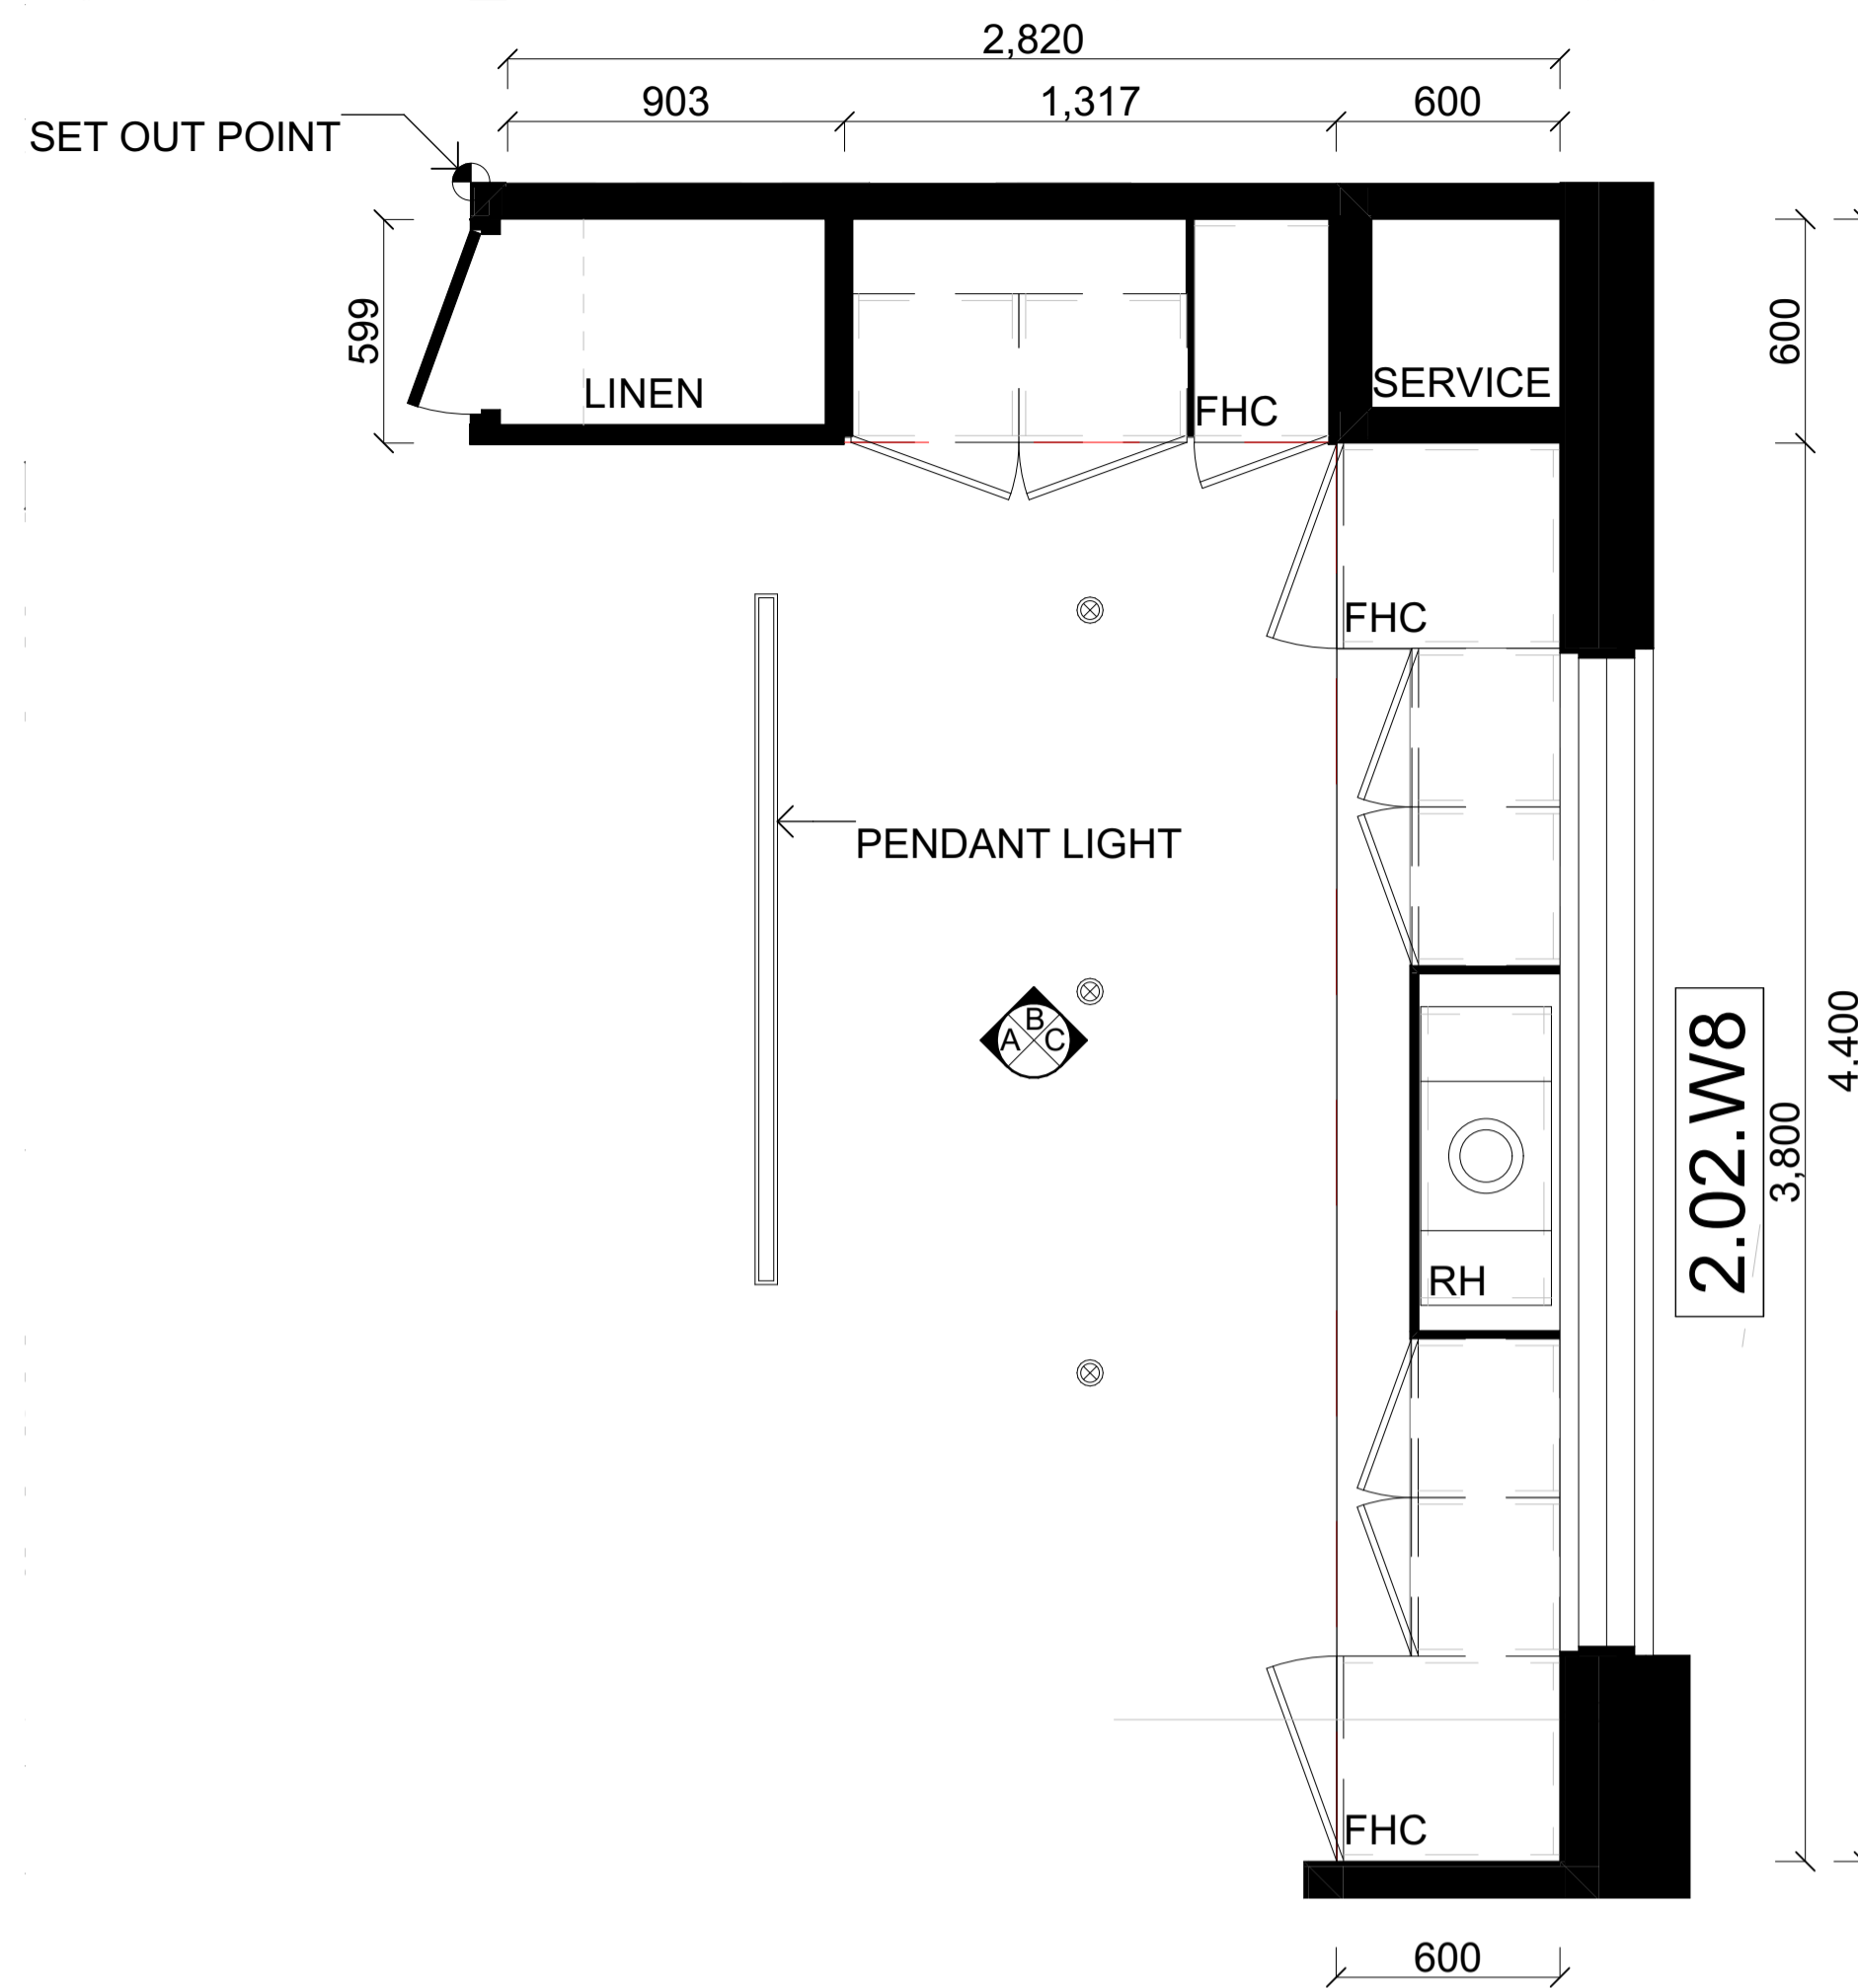

K-F
A02-04 KITCHEN FITOUT OVERHEAD 1:20

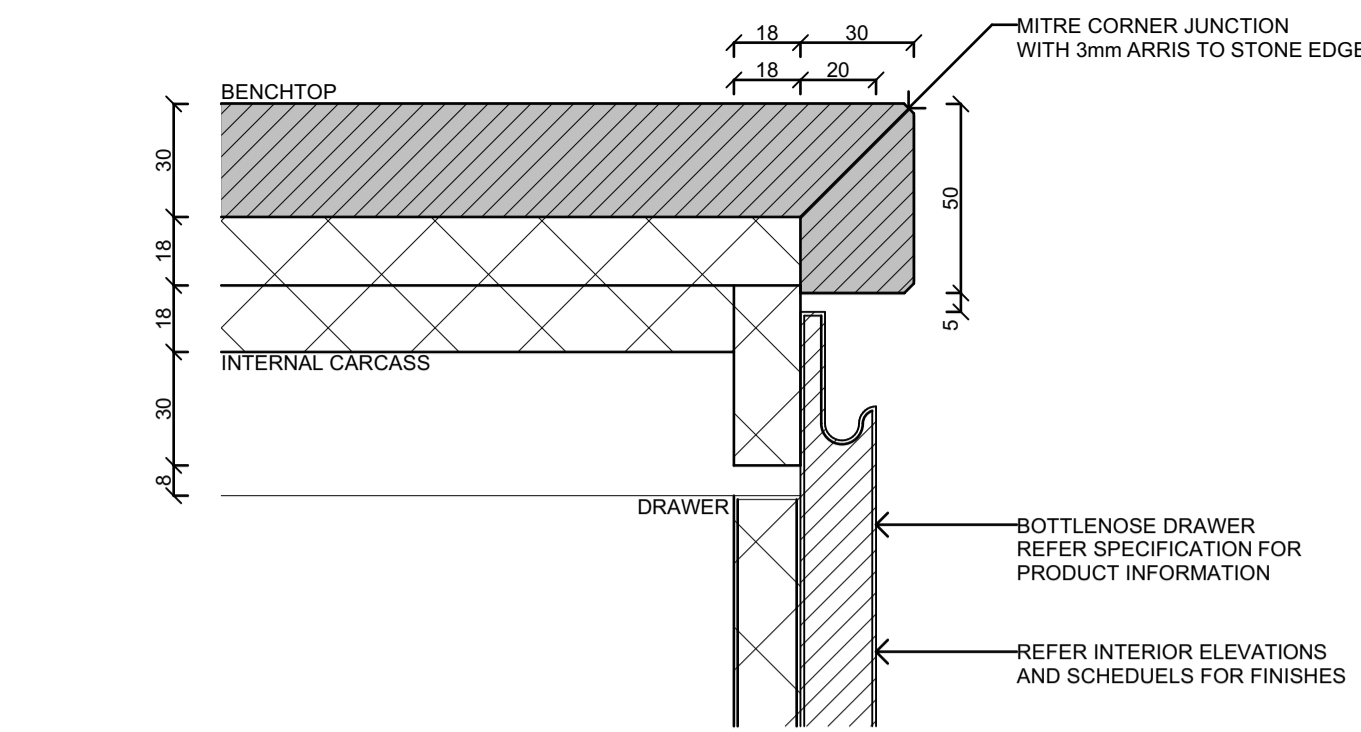


A
V-B TYPICAL BENCH EDGE DETAIL 1:2

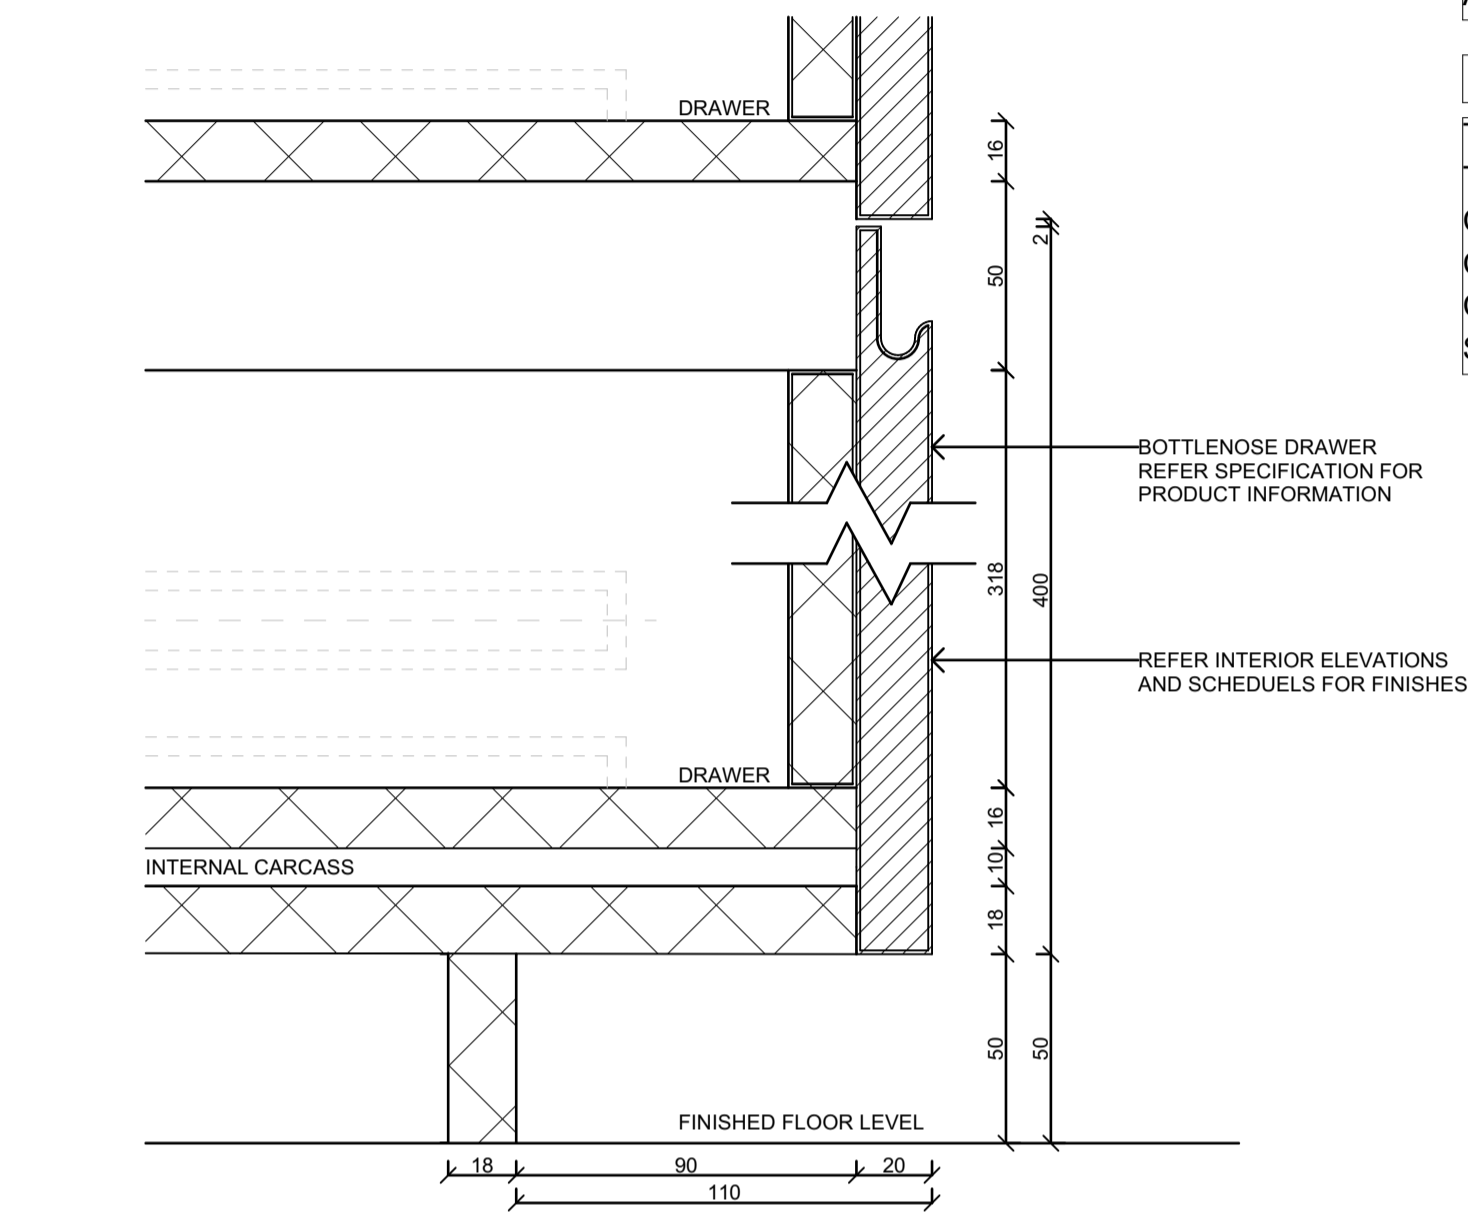


B
V-B TYPICAL KICKPLATE / DRAWER DETAIL 1:2

LEGEND	
OV/CT	OVEN / COOKTOP
RH	RANGE HOOD
FHC	FULL HEIGHT CUPBOARD
REF	REFRIGERATOR
DW	DISH WASHER
AC	AIR CONDITIONER VENT


FINISHES - KITCHEN	
TR-01	PINE LINING WHITE PAINT FINISH
TR-02	BRUSHED BRASS TRIM
CD-01	CUPBOARD DOOR - OFF WHITE
CD-02	CUPBOARD DOOR - LIGHT BROWN
CD-03	CUPBOARD DOOR - FLUTED GLASS
ST-01	STONE BENCHTOP - MARBLE

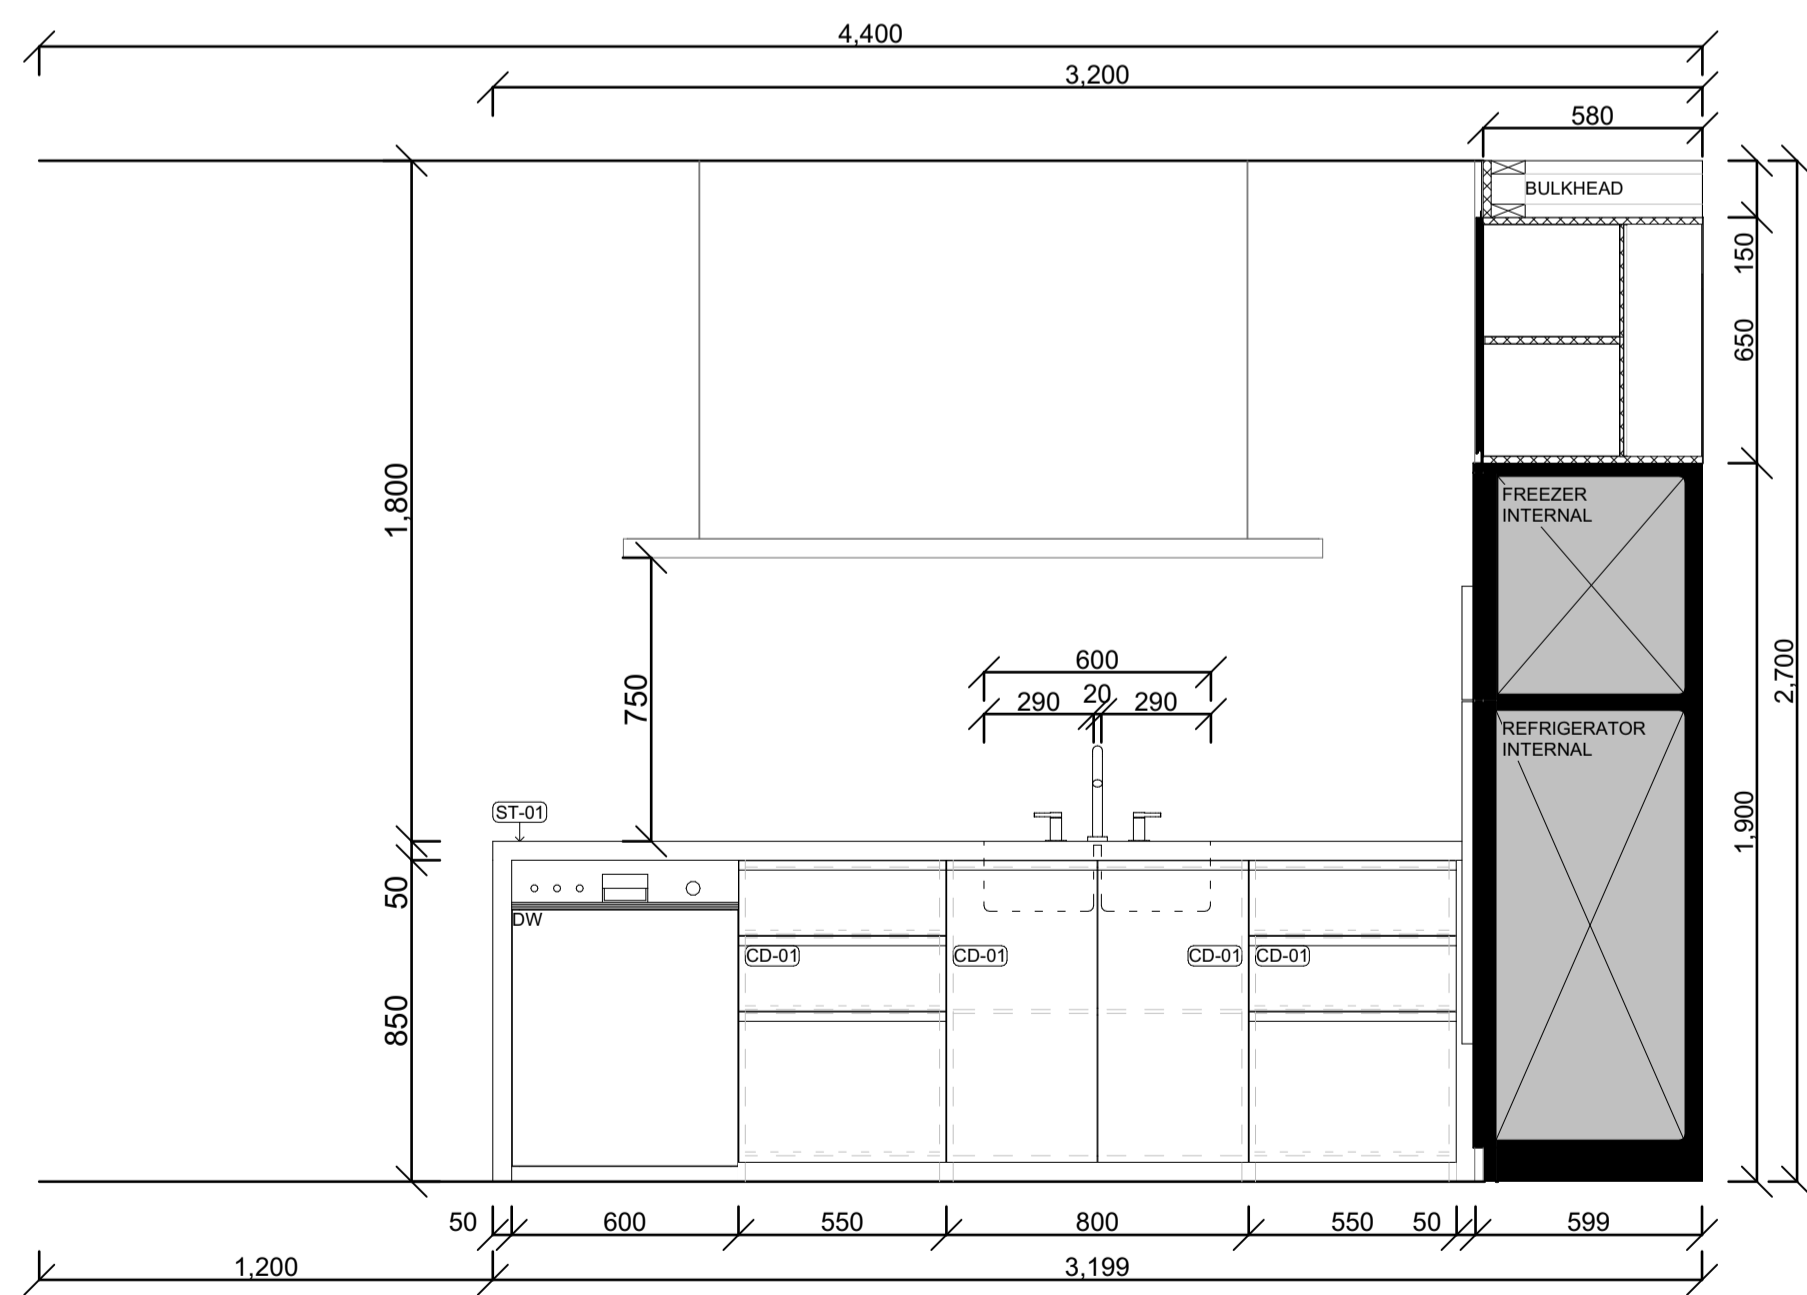

A
K-F VIEW A 1:20

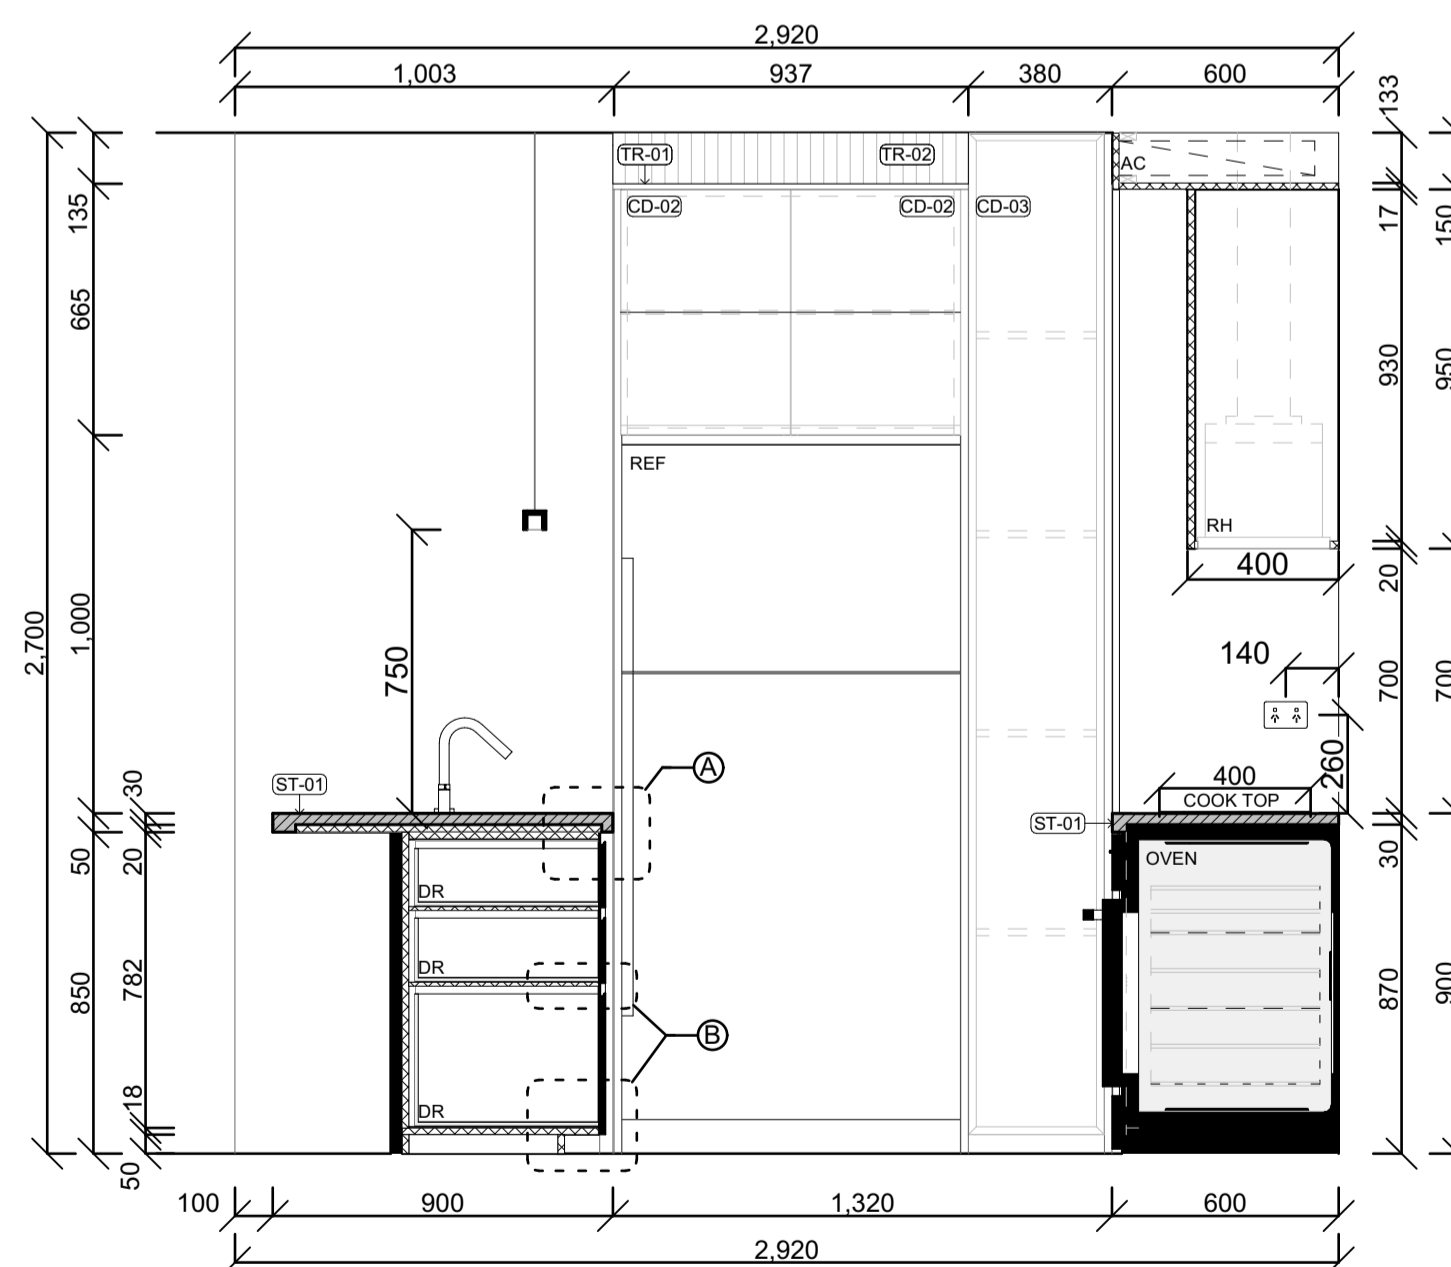

B
K-F VIEW B 1:20

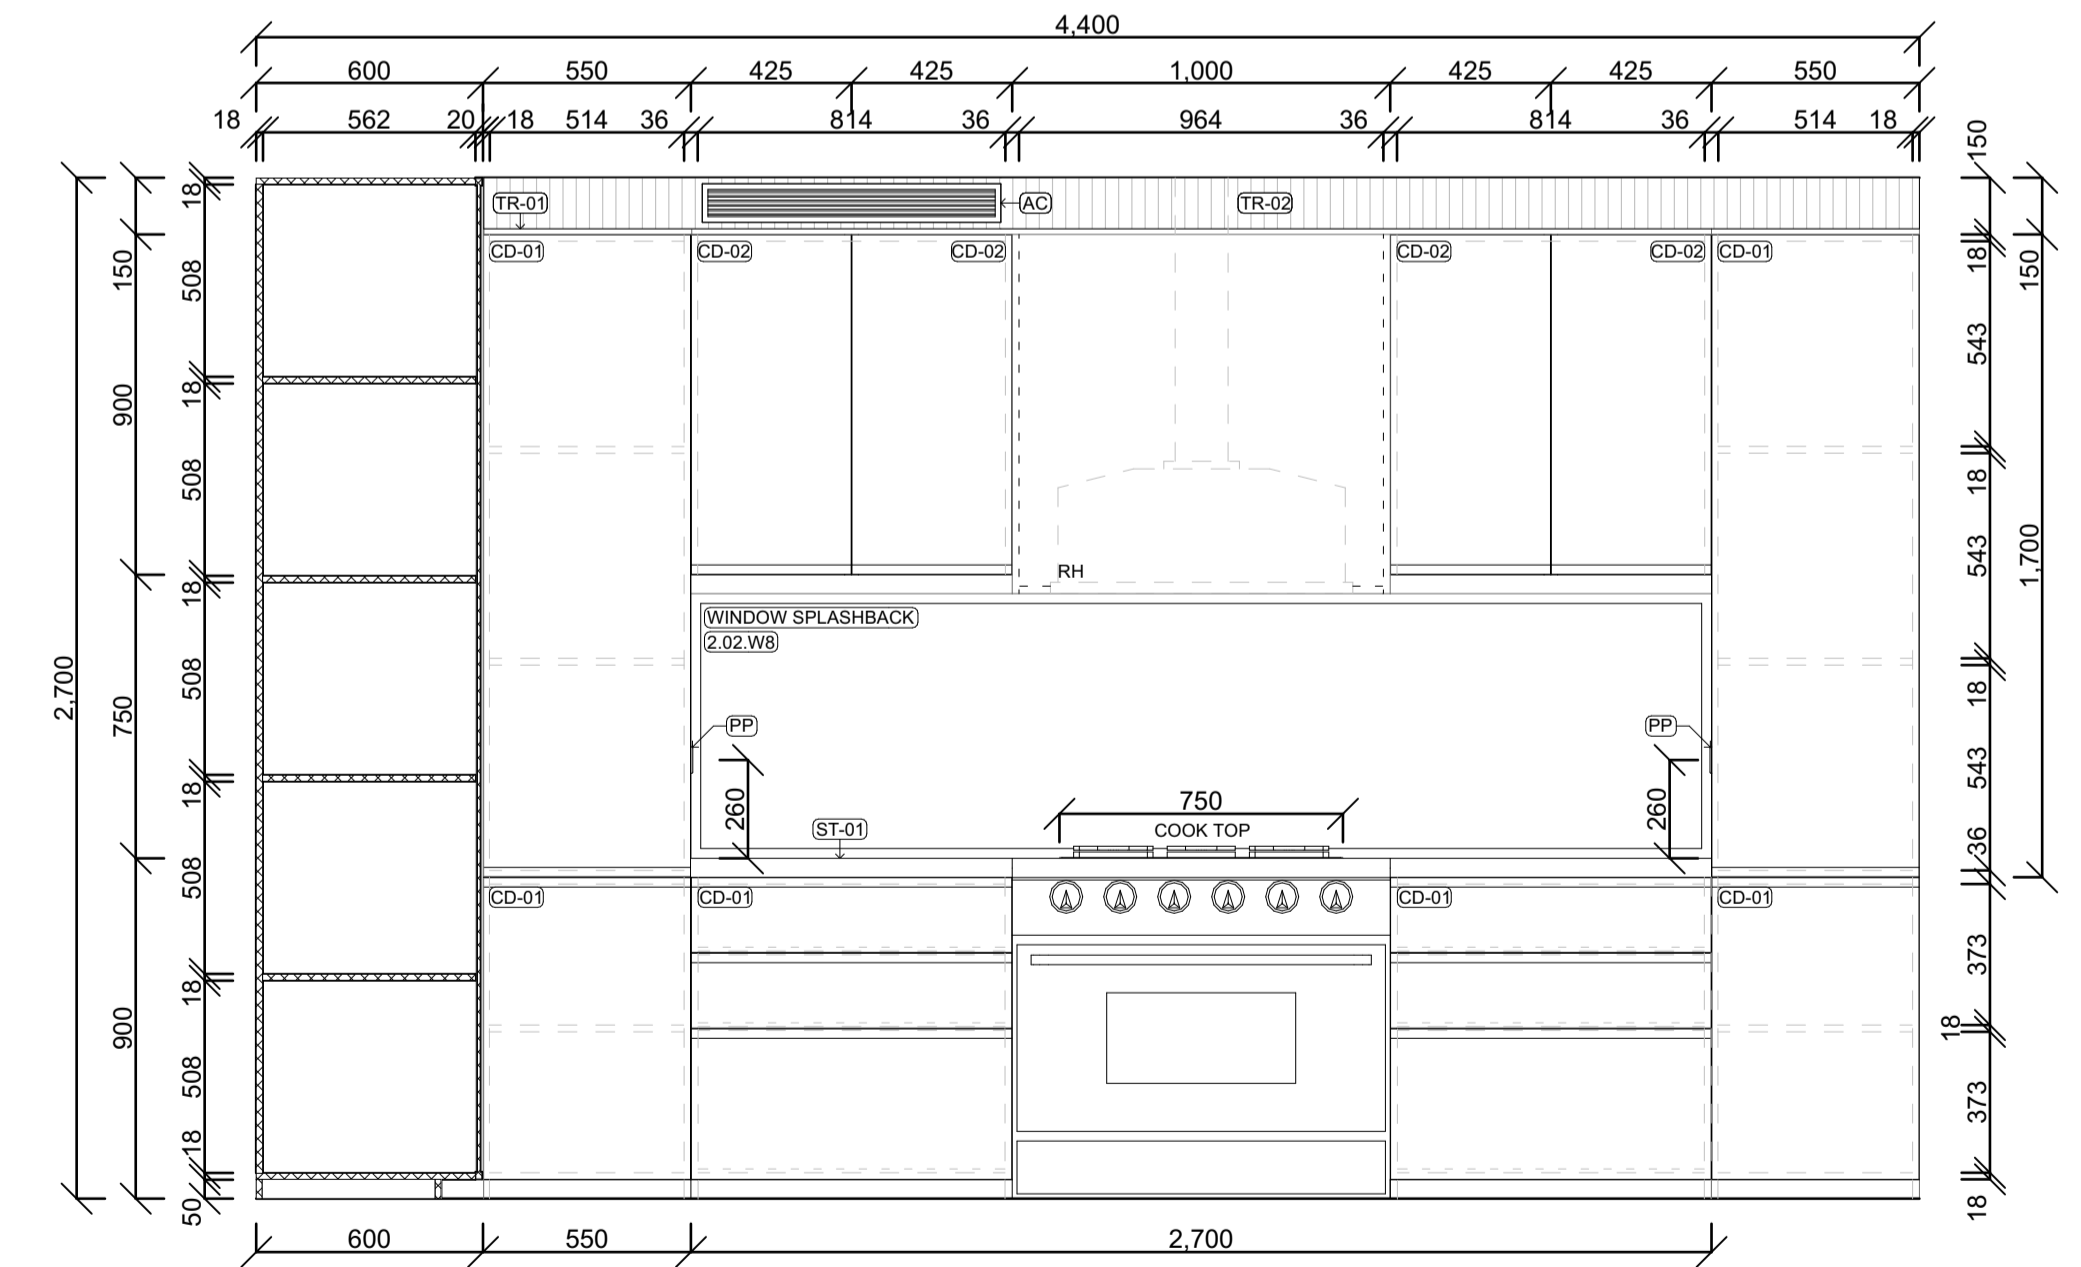

C
K-F VIEW C 1:20

NOTES:
 THE BUILDER SHALL CHECK AND VERIFY ALL DIMENSIONS AND NOTIFY ALL ERRORS AND OMISSIONS TO THE DESIGNER.
 DO NOT SCALE DRAWINGS.
 USE FIGURED DIMENSIONS ONLY. DRAWINGS ARE NOT TO BE USED FOR CONSTRUCTION UNTIL ISSUED BY THE DESIGNER FOR CONSTRUCTION.
 STUDENT DECLARES THAT THIS ASSESSMENT TASK IS HER/HIS OWN WORK UNLESS OTHERWISE ACKNOWLEDGED AND IS IN ACCORDANCE WITH THE INSTITUTE'S PLAGIARISM POLICY. STUDENT ACKNOWLEDGES THAT THE ASSESSOR OF THIS ASSESSMENT TASK MAY:
 1. REPRODUCE THIS ASSESSMENT TASK AND PROVIDE A COPY TO ANOTHER MEMBER OF THE INSTITUTE OR DISPLAY THIS ASSESSMENT WITHIN THE INSTITUTE FOR EDUCATIONAL PURPOSES. 2. SUBMIT THE ASSESSMENT TASK TO PLAGIARISM CHECKING.

JAXON BELL

100660344

22477VIC

Advanced Diploma of Building Design (Architectural)



AT4.2 APARTMENT BUILDING

9-11 BEVIS STREET BENTLEIGH EAST VIC 3165 AUSTRALIA

DRAWING NAME:
KEY INTERNAL AREAS - TYPICAL KITCHEN

FILE: WD_AT4.2_APARTMENT BUILDING.pln


DATE: 14/06/2026

CHECKED: TEACHER

DWG NO: A15-02 REVISION: A


SCALE: 1:20, 1:2 at A1

DOOR SCHEDULE

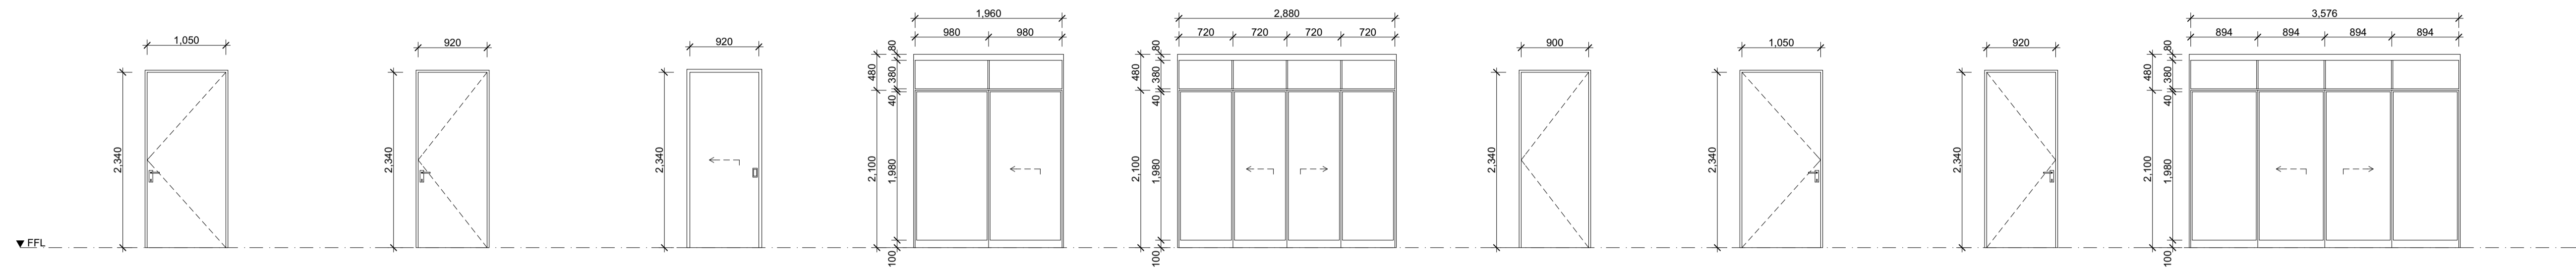


ID	1.01.D01, 1.02.D01, 1.03.D01, 1.04.D01	1.01.D02, 1.01.D05, 1.01.D08, 1.02.D02, 1.02.D03, 1.02.D04, 1.02.D06, 1.03.D02, 1.03.D05, 1.04.D02, 1.04.D04, 1.04.D06	1.01.D03, 1.01.D04, 1.01.D07, 1.02.D07, 1.03.D03, 1.03.D06, 1.04.D03, 1.04.D07, 1.04.D09	1.01.D06	1.02.D05, 1.03.D04, 1.04.D05	1.S.D01	2.01.D01, 2.02.D01	2.01.D02, 2.01.D04, 2.01.D05, 2.01.D08, 2.02.D03, 2.02.D04, 2.02.D08, 2.02.D10	2.01.D03, 2.01.D06, 2.02.D07, 2.02.D09
Manufacturer	CORINTHIAN	CORINTHIAN	CORINTHIAN	RYLOCK	RYLOCK	HUME DOORS & TIMBER	CORINTHIAN	CORINTHIAN	RYLOCK
Frame	ALUMINIUM POWDERCOATED - MONUMENT	TIMBER - PAINT (WHITE)	TIMBER - PAINT (WHITE)	ALUMINIUM POWDERCOATED - MONUMENT	ALUMINIUM POWDERCOATED - MONUMENT	STEEL DOOR FRAME (FIRE DOOR)	ALUMINIUM POWDER COATED - MONUMENT	TIMBER - PAINT (WHITE)	ALUMINIUM POWDERCOATED - MONUMENT
Leaf	TIMBER SOLID CORE - PAINT (MONUMENT)	TIMBER HOLLOW CORE - PAINT (WHITE)	TIMBER HOLLOW CORE - PAINT (WHITE)	DOUBLE GLAZED (LOW-E)	DOUBLE GLAZED (LOW-E)	MONOLITHIC VERMICULITE CORE	TIMBER SOLID CORE - PAINT (MONUMENT)	TIMBER HOLLOW CORE - PAINT (WHITE)	DOUBLE GLAZED (LOW-E)
Level	1FL	1FL	1FL	1FL	1FL	1FL	2FL	2FL	2FL

DOOR SCHEDULE

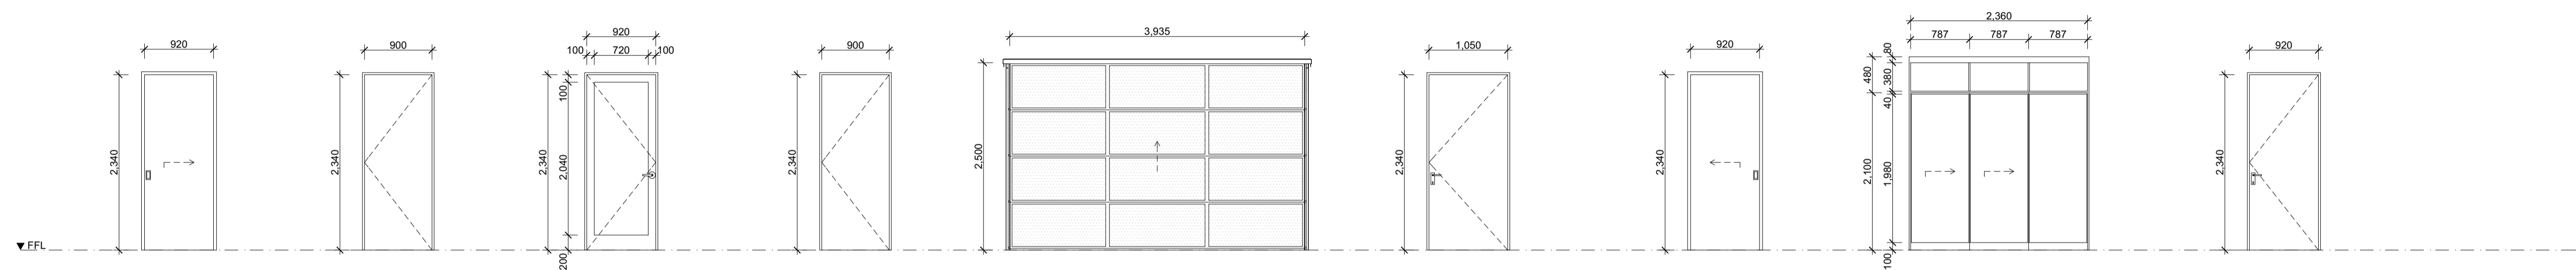


ID	2.01.D07, 2.01.D08, 2.01.D10, 2.02.D02, 2.02.D05, 2.02.D06	2.S.D01	B.S.D01	B.S.D02	B.S.D03	G.01.D01, G.02.D01, G.03.D01, G.04.D01	G.01.D03, G.01.D08, G.01.D.04, G.02.D09, G.03.D03, G.03.D08, G.04.D03, G.04.D08, G.04.D09	G.01.D05	G.01.D06, G.01.D09, G.01.D.02, G.02.D02, G.02.D03, G.02.D04, G.02.D07, G.03.D02, G.03.D07, G.04.D02, G.04.D04, G.04.D07
Manufacturer	CORINTHIAN	HUME DOORS & TIMBER	RYLOCK	HUME DOORS & TIMBER	ECO GARAGE DOORS	CORINTHIAN	CORINTHIAN	RYLOCK	CORINTHIAN
Frame	TIMBER - PAINT (WHITE)	STEEL DOOR FRAME (FIRE DOOR)	ALUMINIUM POWDERCOATED - MONUMENT	STEEL DOOR FRAME (FIRE DOOR)	ALUMINIUM POWDERCOATED - MONUMENT	ALUMINIUM POWDER COATED - MONUMENT	TIMBER - PAINT (WHITE)	ALUMINIUM POWDERCOATED - MONUMENT	TIMBER - PAINT (WHITE)
Leaf	TIMBER HOLLOW CORE - PAINT (WHITE)	MONOLITHIC VERMICULITE CORE	DOUBLE GLAZED (LOW-E)	MONOLITHIC VERMICULITE CORE	PERFALITE (PERFORATED ALUMINIUM) POWDERCOATED - MONUMENT	TIMBER SOLID CORE - PAINT (MONUMENT)	TIMBER HOLLOW CORE - PAINT (WHITE)	DOUBLE GLAZED (LOW-E)	TIMBER HOLLOW CORE - PAINT (WHITE)
Level	2FL	2FL	BASEMENT	BASEMENT	BASEMENT	GFL	GFL	GFL	GFL

DOOR SCHEDULE

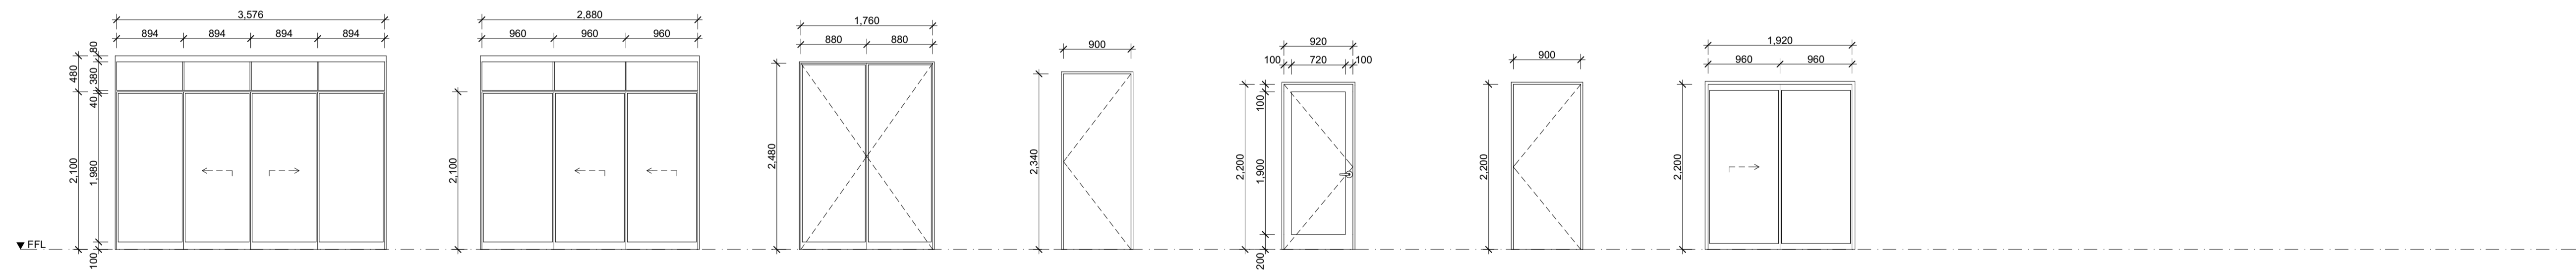

ID	G.01.D07, G.04.D05	G.02.D05, G.02.D06, G.02.D08, G.03.D04, G.03.D05, G.03.D08, G.04.D06	G.S.D01	G.S.D02	R.S.D01	R.S.D02	R.S.D03
Manufacturer	RYLOCK	RYLOCK	RYLOCK	HUME DOORS & TIMBER	RYLOCK	HUME DOORS & TIMBER	RYLOCK
Frame	ALUMINIUM POWDERCOATED - MONUMENT	ALUMINIUM POWDERCOATED - MONUMENT	ALUMINIUM POWDERCOATED - MONUMENT	STEEL DOOR FRAME (FIRE DOOR)	ALUMINIUM POWDERCOATED - MONUMENT	STEEL DOOR FRAME (FIRE DOOR)	ALUMINIUM POWDERCOATED - MONUMENT
Leaf	DOUBLE GLAZED (LOW-E)	DOUBLE GLAZED (LOW-E)	DOUBLE GLAZED (LOW-E)	MONOLITHIC VERMICULITE CORE	DOUBLE GLAZED (LOW-E)	MONOLITHIC VERMICULITE CORE	DOUBLE GLAZED (LOW-E)
Level	GFL	GFL	GFL	GFL	RFL	RFL	RFL

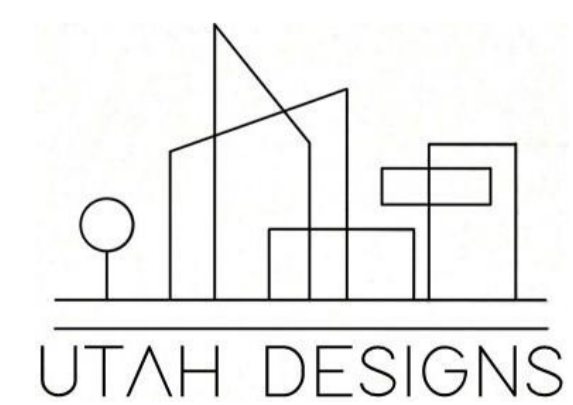

Rev	ChID	Description	Date
P		TR PRELIMINARY SUBMISSION	4/06/26
A	F	FINAL SUBMISSION	12/06/26

NOTES:
 THE BUILDER SHALL CHECK AND VERIFY ALL DIMENSIONS AND NOTIFY ALL ERRORS AND OMISSIONS TO THE DESIGNER.
 DO NOT SCALE DRAWINGS.
 USE FIGURED DIMENSIONS ONLY. DRAWINGS ARE NOT TO BE USED FOR CONSTRUCTION UNTIL ISSUED BY THE DESIGNER FOR CONSTRUCTION.
 STUDENT DECLARES THAT THIS ASSESSMENT TASK IS HER/HIS OWN WORK UNLESS OTHERWISE ACKNOWLEDGED AND IS IN ACCORDANCE WITH THE INSTITUTE'S PLAGIARISM POLICY. STUDENT ACKNOWLEDGES THAT THE ASSESSOR OF THIS ASSESSMENT TASK MAY: 1. REPRODUCE THIS ASSESSMENT TASK AND PROVIDE A COPY TO ANOTHER MEMBER OF THE INSTITUTE OR DISPLAY THIS ASSESSMENT WITHIN THE INSTITUTE FOR EDUCATIONAL PURPOSES. 2. SUBMIT THE ASSESSMENT TASK TO PLAGIARISM CHECKING.

JAXON BELL
 100660344
 22477VIC
 Advanced Diploma of Building Design (Architectural)

AT4.2 APARTMENT BUILDING
 9-11 BEVIS STREET BENTLEIGH EAST
 VIC 3165 AUSTRALIA

DRAWING NAME:
 DOOR SCHEDULE


FILE: WD_AT4.2_APARTMENT BUILDING.pln

DATE: 14/06/2026 **CHECKED:** TEACHER

DWG NO: A16-01 **REVISION:** A


SCALE: 1:50 **at** A1

WINDOW SCHEDULE

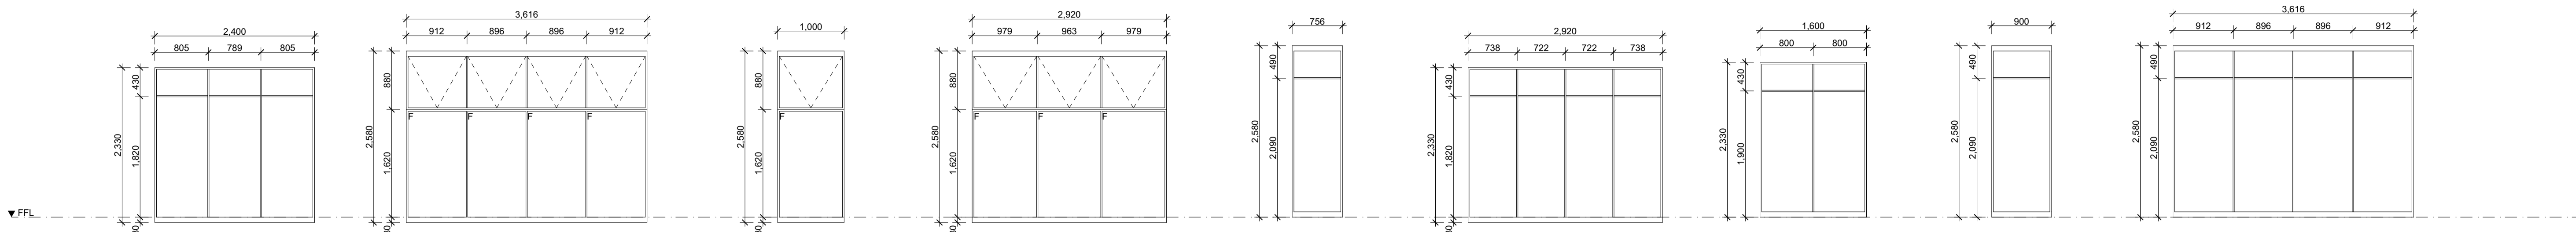


ID	1.01.W1, 1.01.W2, 1.04.W5, 1.04.W7	1.01.W3, 1.04.W4	1.01.W4, 1.01.W5, 1.02.W1, 1.02.W2, 1.02.W3, 1.02.W4, 1.03.W5, 1.03.W6, 1.03.W7, 1.04.W1, 1.04.W2, 1.04.W3	1.02.W5, 1.03.W4	1.02.W6, 1.02.W7, 1.03.W2, 1.03.W3	1.02.W8, 1.03.W1	1.04.W6	2.01.W1, 2.01.W2, 2.01.W3, 2.02.W10, 2.02.W11, 2.02.W12	2.01.W4, 2.02.W9
Manufacturer	RYLOCK	RYLOCK	RYLOCK	RYLOCK	RYLOCK	RYLOCK	RYLOCK	RYLOCK	RYLOCK
Frame	ALUMINIUM POWDERCOATED - MONUMENT	ALUMINIUM POWDERCOATED - MONUMENT	ALUMINIUM POWDERCOATED - MONUMENT	ALUMINIUM POWDERCOATED - MONUMENT	ALUMINIUM POWDERCOATED - MONUMENT	ALUMINIUM POWDERCOATED - MONUMENT	ALUMINIUM POWDERCOATED - MONUMENT	ALUMINIUM POWDERCOATED - MONUMENT	ALUMINIUM POWDERCOATED - MONUMENT
Glazing	DOUBLE GLAZED (LOW-E)	DOUBLE GLAZED (LOW-E) - FROSTED LOWER	DOUBLE GLAZED (LOW-E) - FROSTED LOWER	DOUBLE GLAZED (LOW-E) - FROSTED LOWER	DOUBLE GLAZED (LOW-E)	DOUBLE GLAZED (LOW-E)	DOUBLE GLAZED (LOW-E)	DOUBLE GLAZED (LOW-E)	DOUBLE GLAZED (LOW-E)
Level	1FL	1FL	1FL	1FL	1FL	1FL	1FL	2FL	2FL

WINDOW SCHEDULE

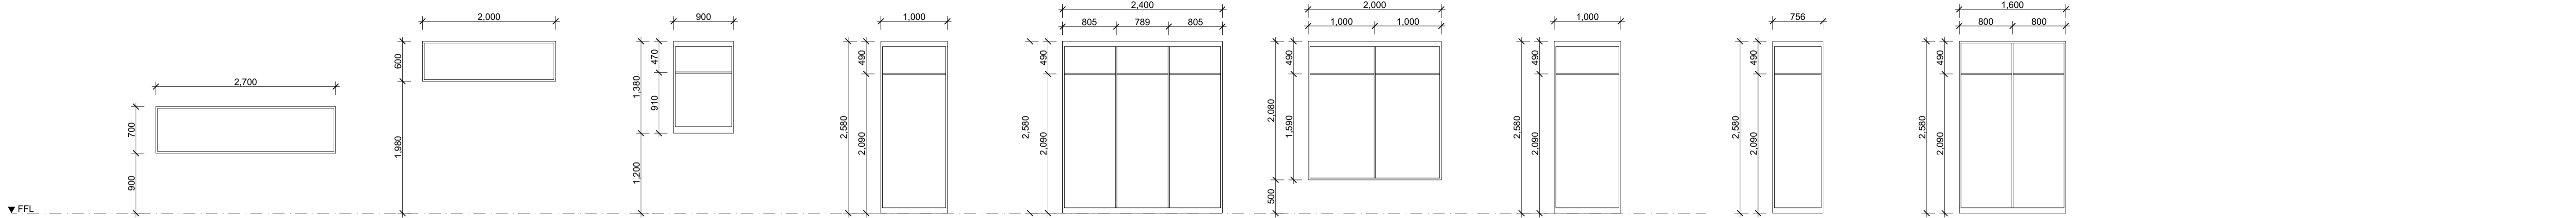


ID	2.01.W5, 2.02.W8	2.01.W6, 2.02.W7	2.01.W7, 2.01.W8, 2.01.W9, 2.02.W4, 2.02.W5, 2.02.W6	2.01.W10, 2.01.W11, 2.01.W12, 2.02.W1, 2.02.W2, 2.02.W3	G.01.W1, G.04.W4, G.04.W5	G.01.W2	G.01.W3, G.01.W4, G.02.W1, G.02.W2, G.02.W3, G.02.W4, G.03.W3, G.03.W4, G.03.W5, G.04.W1, G.04.W2, G.04.W3	G.02.W5, G.02.W6, G.03.W1, G.03.W2	G.04.W5
Manufacturer	RYLOCK	RYLOCK	RYLOCK	RYLOCK	RYLOCK	RYLOCK	RYLOCK	RYLOCK	RYLOCK
Frame	ALUMINIUM POWDERCOATED - MONUMENT	ALUMINIUM POWDERCOATED - MONUMENT	ALUMINIUM POWDERCOATED - MONUMENT	ALUMINIUM POWDERCOATED - MONUMENT	ALUMINIUM POWDERCOATED - MONUMENT	ALUMINIUM POWDERCOATED - MONUMENT	ALUMINIUM POWDERCOATED - MONUMENT	ALUMINIUM POWDERCOATED - MONUMENT	ALUMINIUM POWDERCOATED - MONUMENT
Glazing	DOUBLE GLAZED (LOW-E)	DOUBLE GLAZED (LOW-E)	DOUBLE GLAZED (LOW-E)	DOUBLE GLAZED (LOW-E)	DOUBLE GLAZED (LOW-E)	DOUBLE GLAZED (LOW-E)	DOUBLE GLAZED (LOW-E)	DOUBLE GLAZED (LOW-E)	DOUBLE GLAZED (LOW-E)
Level	2FL	2FL	2FL	2FL	GFL	GFL	GFL	GFL	GFL

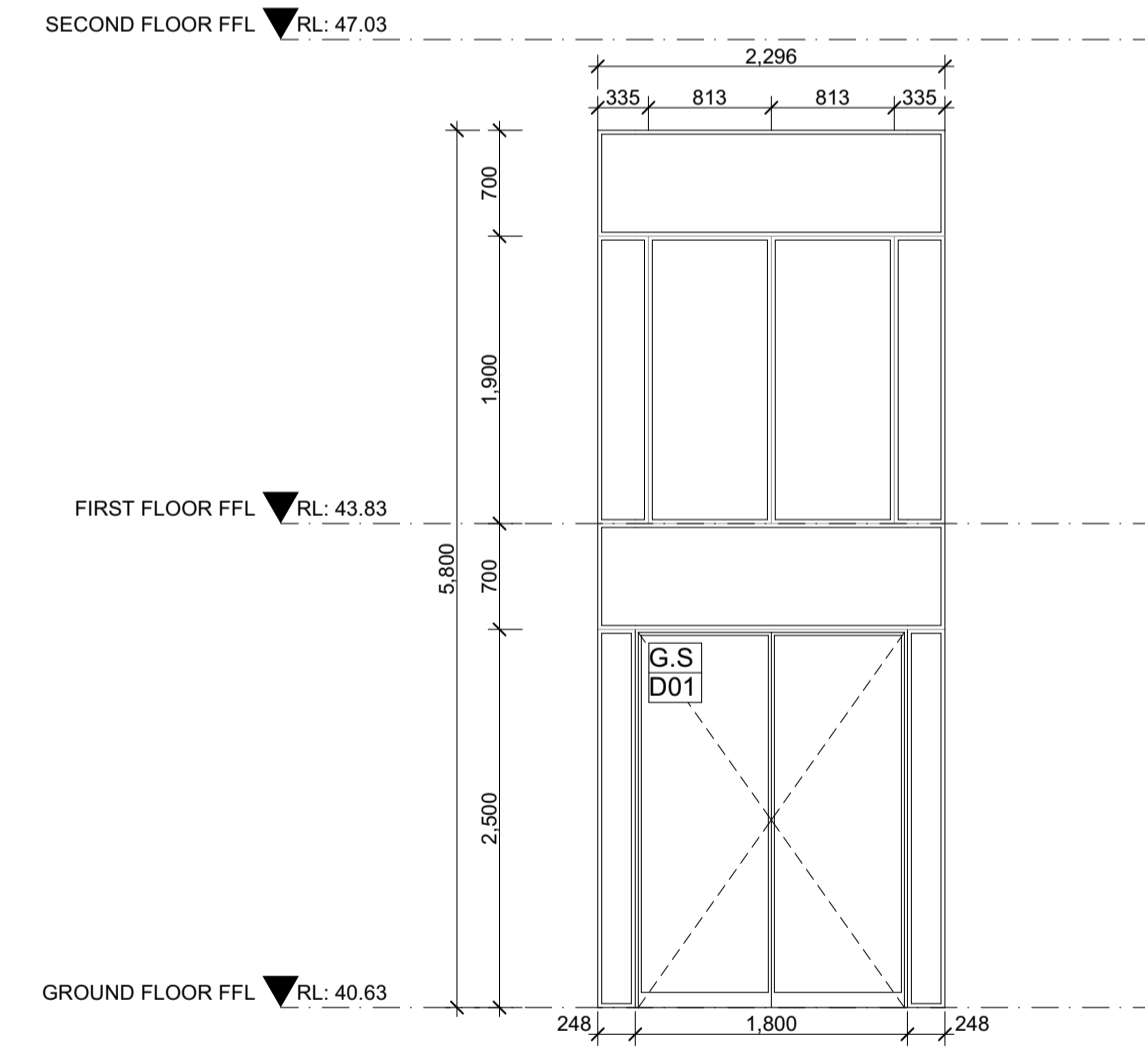

FRAME ALUMINIUM POWDER COATED - MONUMENT
GLAZING DOUBLE GLAZED (LOW-E)

2 CURTAIN WALL SCHEDULE
1:50

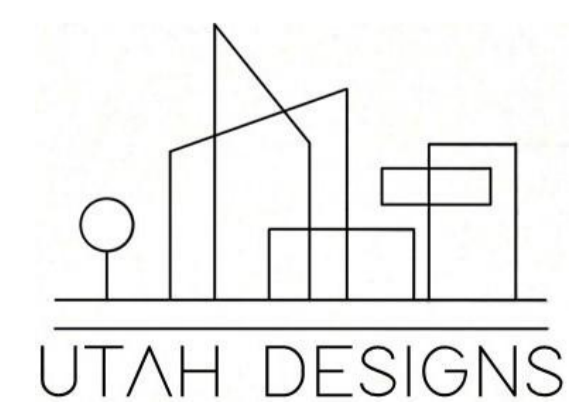

Rev	ChID	Description	Date
P	TR	PRELIMINARY SUBMISSION	4/06/26
A	F	FINAL SUBMISSION	12/06/26

NOTES:
THE BUILDER SHALL CHECK AND VERIFY ALL DIMENSIONS AND NOTIFY ALL ERRORS AND OMISSIONS TO THE DESIGNER.
DO NOT SCALE DRAWINGS.
USE FIGURED DIMENSIONS ONLY. DRAWINGS ARE NOT TO BE USED FOR CONSTRUCTION UNTIL ISSUED BY THE DESIGNER FOR CONSTRUCTION.

STUDENT DECLARES THAT THIS ASSESSMENT TASK IS HER/HIS OWN WORK UNLESS OTHERWISE ACKNOWLEDGED AND IS IN ACCORDANCE WITH THE INSTITUTE'S PLAGIARISM POLICY. STUDENT ACKNOWLEDGES THAT THE ASSESSOR OF THIS ASSESSMENT TASK MAY:
1. REPRODUCE THIS ASSESSMENT TASK AND PROVIDE A COPY TO ANOTHER MEMBER OF THE INSTITUTE OR DISPLAY THIS ASSESSMENT WITHIN THE INSTITUTE FOR EDUCATIONAL PURPOSES. 2. SUBMIT THE ASSESSMENT TASK TO PLAGIARISM CHECKING.

JAXON BELL
100660344
22477VIC
Advanced Diploma of Building Design (Architectural)

AT4.2 APARTMENT BUILDING
9-11 BEVIS STREET BENTLEIGH EAST
VIC 3165 AUSTRALIA

DRAWING NAME:
WINDOW SCHEDULE

FILE: WD_AT4.2_APARTMENT BUILDING.pln

DATE: 14/06/2026 **CHECKED:** TEACHER

DWG NO: A16-02 **REVISION:** A

SCALE: 1:50 **at** A1